CHERRY AVENUE STREETSCAPE IMPROVEMENTS

FROM 7-1/2 STREET SW TO 6TH STREET SW CITY OF CHARLOTTESVILLE, VIRGINIA

ALIGNMENT/GRADING ABBREVIATIONS

EXISTING FEATURES LEGEND

CONC.		CONCRETE
C&G		CURB & GUTTER
D.I.		DROP INLET
EO		ELECTRIC OUTLET
FH		FIRE HYDRANT
GB		GAS BOX
GV		GAS VALVE
INV		INVERT
МВ		MAILBOX
MH		MANHOLE
TP		TELEPHONE PEDESTAL
UB		ULITILY BOX
WM		WATER METER
WV		WATER VALVE
	— –	CONTOURS
××	×	FENCE
		OVERHEAD UTILITY LINE
		R.O.W. OR PROPERTY LINE
		UNDERGROUND WATER LINE
cc		UNDERGROUND COMMUNICATION
——Е ———Е -		UNDERGROUND ELECTRIC LINE

SURVEY NOTES

1. UTILITY MARKING WAS REQUESTED UNDER MISS UTILITY TICKET A331701735-00A.

____G ____ UNDERGROUND GAS LINE

- 2. HORIZONTAL DATUM: VIRGINIA STATE PLANE COORDINATES-SOUTH ZONE NAD83 USING GPS & OPUS. VERTICAL DATUM: NAVD88 USING GPS & OPUS.
- 3. COMPLETE VISIBLE UNDERGROUND UTILITY
 INFORMATION WAS ONLY PROVIDED IN THE FOLLOWING
 FOUR PORTIONS OF CHERRY AVENUE:
 100' IN EACH DIRECTION FROM THE CENTER OF THE
 INTERSECTIONS WITH 6TH ST SW, 6 1/2 ST SW & 7 1/2
 ST SW AND IN FRONT OF TAX MAP 30 PARCELS 140,
 141 & 144.10.
- 4. THIS TOPOGRAPHIC SURVEY WAS COMPLETED UNDER THE DIRECT AND RESPONSIBLE CHARGE OF BRIAN S. RAY OF ROGER W. RAY & ASSOCIATES, INC. FROM AN ACTUAL GROUND SURVEY MADE UNDER MY SUPERVISION; I CERTIFY THAT THE IMAGERY AND/OR ORIGINAL DATA WAS OBTAINED ON JANUARY 8, 2014; AND THAT THIS PLAT, MAP, OR DIGITAL GEOSPATIAL DATA INCLUDING METADATA MEETS MINIMUM ACCURACY STANDARDS UNLESS OTHERWISE NOTED.

DESIGN CRITERIA

- 1. DESIGN SPEED = 35MPH
- AVERAGE DAILY TRAFFIC = 12,000 VEHICLES/DAY
 VDOT FUNCTIONAL CLASSIFICATION = URBAN MINOR ARTERIAL

ANDARD ABBREVIATIONS

EDGE OF PAVEMENT EDGE OF ROAD

FOUNDATION
GRAVEL
HOT MIX ASPHALT
INSIDE DIAMETER
LANDSCAPED AREA
LINEAR FEET
LIMIT OF GRADING
LIMITS OF DISTURBANCE

MINIMUM

NOT IN CONTRACT

REMOVE AND DISPOSE

REMOVE AND RESET

REMOVE AND STACK SOUTHBOUND

STOPPING SIGHT DISTANCE

SQUARE FEET

STATION

SIDEWALK

TEMPORARY

TRANSITION

WESTBOUND

TYPICAL

NOT TO SCALE

ON CENTER
OUTSIDE DIAMETER

PROJECT

PROPOSED

PAVEMENT

REMOVE RIGHT-OF-WAY

PROP

PVMT

ROW

R&D

R&S


TEMP

ADJ


	ABANDON	ВС	BOTTOM OF CURB
	ACRES	BOC	BACK OF CURB
	ADJUST	BR	BOTTOM OF RAMP
ΙX	APPROXIMATE	DORΔ	DELTA ANGLE
	BASELINE	FOC	FACE OF CURB
	BUILDING	L	LENGTH
	BENCHMARK	PC	POINT OF CURVATURE
	BY OTHERS	PCC	POINT OF COMPOUND CURVATURE
	BOTTOM OF SLOPE	PI	POINT OF INTERSECTION
	CONCRETE CURB	PNT	POINT
	CEMENT	PRC	POINT OF REVERSE CURVATURE
	CENTERLINE	PΤ	POINT OF TANGENCY
	CHAINLINK FENCE	R	RADIUS
	CURB RAMP	Т	TANGENT DISTANCE
	CONCRETE	TC	TOP OF CURB
-	CONSTRUCTION	TR	TOP OF RAMP
	DROP INLET		
	EASTBOUND		
	ELEVATION.		

SHEET INDEX

C0.0 TITLE SHEET, LEGEND & DRAWING INDEX
C1.0-C1.1 GENERAL NOTES & SEQUENCE OF CONSTRUCTION
C2.0 TYPICAL SECTIONS
C3.0-C3.2 DEMOLITION & EROSION & SEDIMENT CONTROL
C4.0-C4.2 GEOMETRIC PLANS
C5.0-C5.2 PAVING & GRADING PLANS
C6.0-C6.4 SIGNING & MARKING PLANS
C7.0 LANDSCAPE PLANS
C8.0-C8.2 STANDARD DETAILS

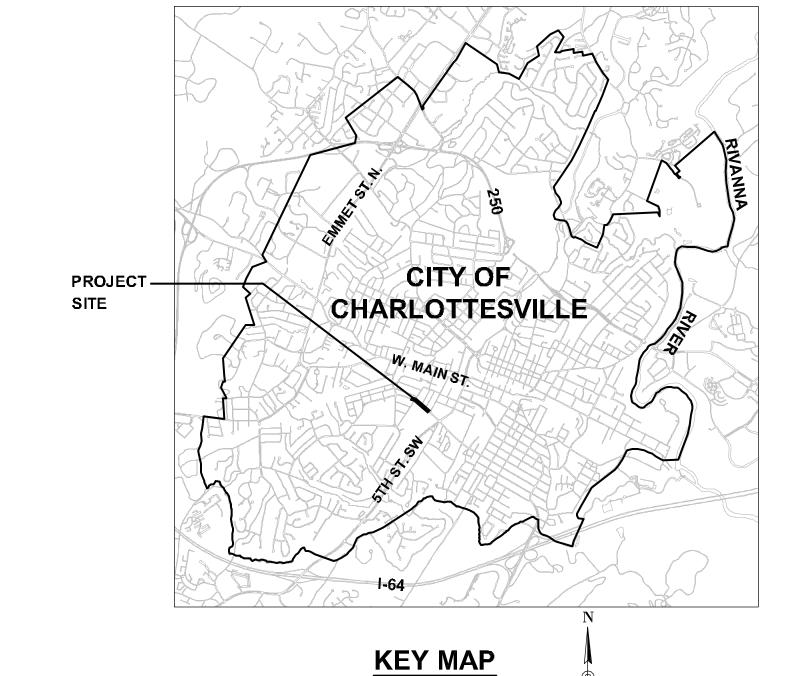

SCALE 1" = 4000'

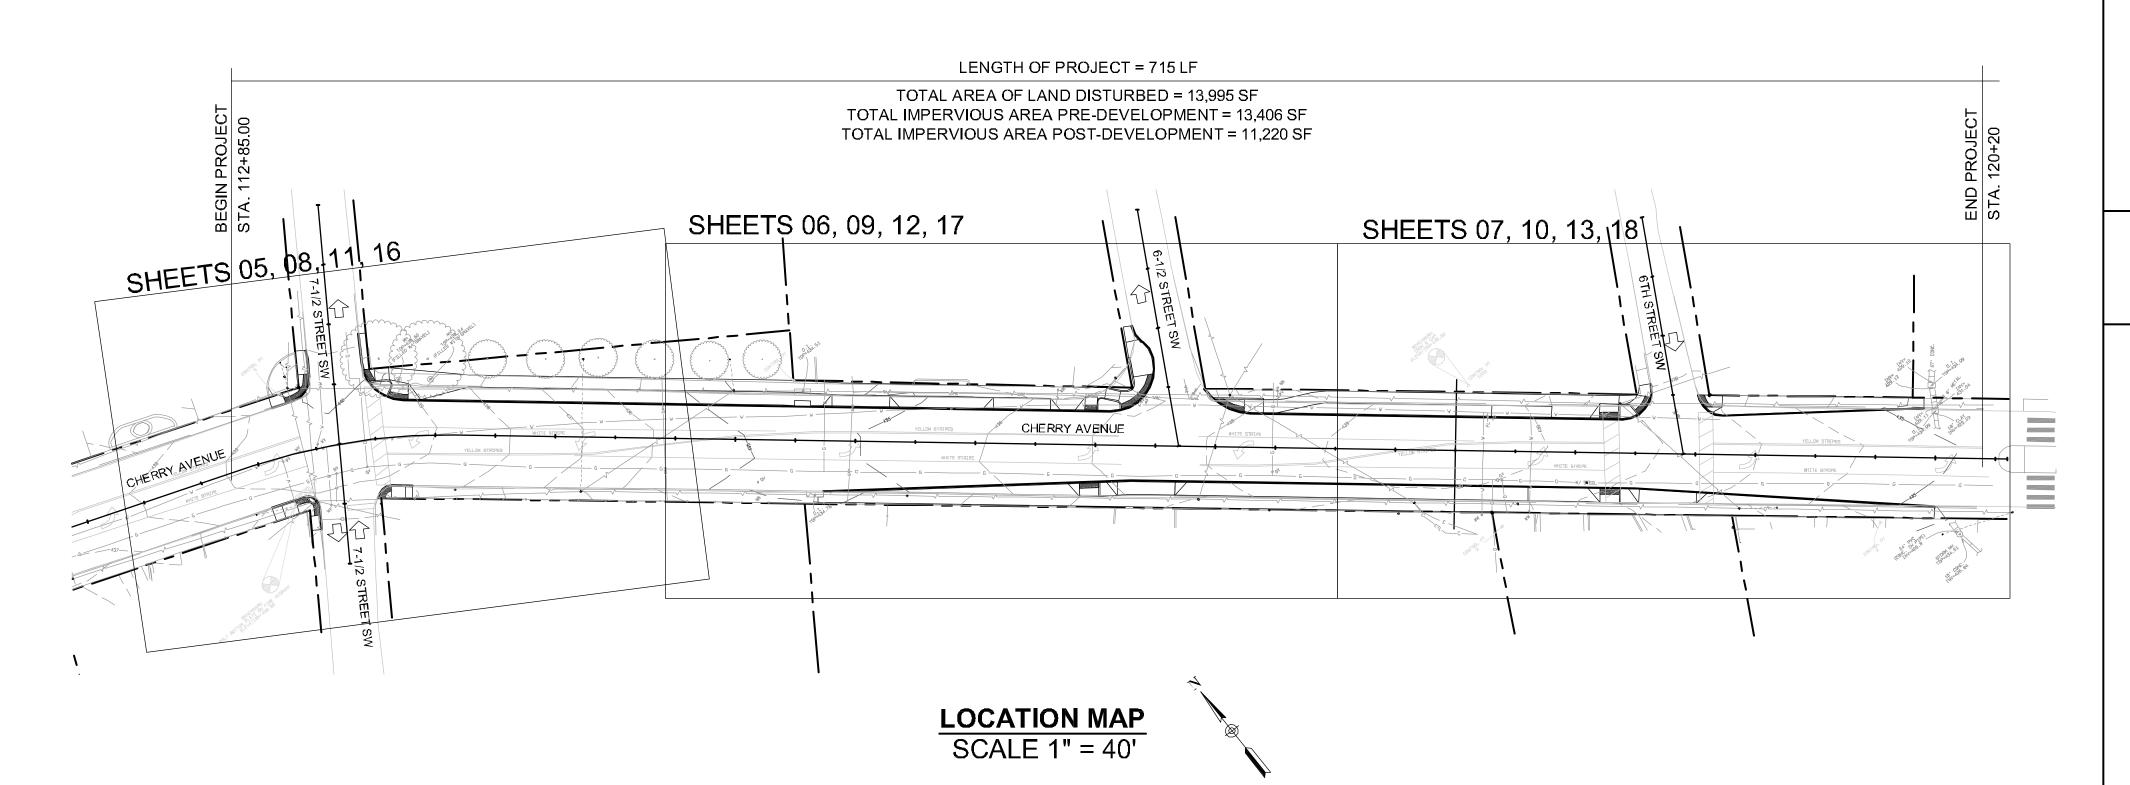

Design Grou

8484 GEORGIA AVENUE, SUITE 800, SILVEF

CHEKKY AVEINUE -1/2 STREET SW TO 6TH STREET SM CHARLOTTESVILLE, VA

PREPARED: EL/JD/MK
CHECKED: EM/MAB

04/28/14

REV.2 - REV.3 -

SHEET NAME
TITLE SHEET,
LEGEND &
DRAWING INDEX
DRAWING NUMBER

C0.0

SHEET NUMBER 01 of 22

GENERAL NOTES

LITHITIES

- PRIOR TO CONSTRUCTION OR EXCAVATION, THE CONTRACTOR SHALL ASSUME RESPONSIBILITY OF LOCATING ANY AND ALL UNDERGROUND UTILITIES (PUBLIC OR PRIVATE) THAT MAY EXIST WITHIN OR CROSS THROUGH THE AREA OF CONSTRUCTION WHETHER OR NOT THEY ARE SHOWN ON THE PLANS. PRIOR TO ANY CONSTRUCTION ACTIVITY, THE CONTRACTOR SHALL CALL 'MISS UTILITY OF VIRGINIA' AT 1-800-552-7001. THE CONTRACTOR SHALL BE RESPONSIBLE FOR REPAIRING, AT HIS SOLE EXPENSE, ANY EXISTING UTILITY DAMAGED DURING CONSTRUCTION.
- 2. THE PLAN DOES NOT GUARANTEE THE EXISTENCE, NONEXISTENCE, SIZE, TYPE, LOCATION, ALIGNMENT, OR DEPTH OF ANY OR ALL UNDERGROUND UTILITIES OR OTHER FACILITIES. WHERE SURFACE FEATURES (MANHOLES, CATCH BASINS, VALVES, ETC.) ARE UNAVAILABLE OR INCONCLUSIVE. INFORMATION SHOWN MAY BE FROM UTILITY OWNER'S RECORDS AND/OR ELECTRONIC LINE TRACING, THE RELIABILITY OF WHICH IS UNCERTAIN. THE CONTRACTOR SHALL PERFORM TEST EXCAVATIONS OR OTHER INVESTIGATION AS NECESSARY TO VERIFY LOCATION AND CLEARANCES.
- 3. WHEN THE WORK CROSSES EXISTING UTILITIES, THE EXISTING UTILITIES SHALL BE ADEQUATELY SUPPORTED AND PROTECTED FROM THE DAMAGE DUE TO THE WORK. ALL METHODS FOR SUPPORTING AND MAINTAINING THE EXISTING UTILITIES SHALL BE APPROVED BY THE RESPECTIVE UTILITY COMPANY AND/OR THE ENGINEER. CONTRACTOR SHALL EXERCISE CARE TO INSURE THAT THE GRADE AND ALIGNMENT OF EXISTING UTILITIES ARE MAINTAINED AND THAT NO JOINTS OR CONNECTIONS ARE DISPLACED. BACKFILL SHALL BE CAREFULLY PLACED AND COMPACTED TO PREVENT FUTURE DAMAGE OR SETTLEMENT TO EXISTING UTILITIES. ANY UTILITIES REMOVED AS PART OF THE WORK, AND NOT INDICATED TO BE REMOVED OR ABANDONED, SHALL BE RESTORED USING MATERIALS AND INSTALLATION EQUAL TO THE UTILITY'S STANDARDS.
- 4. CONTRACTOR SHALL NOTIFY LANDOWNERS, TENANTS AND THE ENGINEER A MINIMUM OF 72 HOURS PRIOR TO THE INTERRUPTION OF ANY SERVICES. SERVICE INTERRUPTIONS SHALL BE KEPT TO A MINIMUM.
- 5. CONTRACTOR TO MAKE ANY NECESSARY ADJUSTMENTS TO ALL UTILITY JUNCTION BOXES, VALVE BOXES, MANHOLES, CLEAN-OUTS, AND OTHER GRADE RELATED ITEMS IN SIDEWALK, ROADWAY, AND/OR ADJACENT AREAS TO MATCH FINISHED GRADE. COSTS ARE TO BE INCLUDED UNDER THE VARIOUS UNIT BID ITEMS. NO SEPARATE PAYMENT WILL BE MADE.

EROSION CONTROL & WORK AREA PROTECTION AND MAINTENANCE

- CONTRACTOR IS PERMITTED TO WORK IN THE PUBLIC RIGHT-OF-WAY AND ANY TEMPORARY OR PERMANENT EASEMENT SHOWN ON THE PLANS. HOWEVER, CONTRACTOR SHALL NOTIFY PROPERTY OWNER(S) FORTY-EIGHT (48) HOURS PRIOR TO WORKING ON ANY PRIVATE PROPERTY TO COORDINATE ACCESS AND TO DETERMINE A STORAGE AREA FOR MATERIALS IF NEEDED. COORDINATION OF ACCESS TO PUBLIC RIGHT-OF-WAY AND STORAGE OF MATERIALS THEREON SHALL BE COORDINATED WITH THE ENGINEER. CONTRACTOR'S FAILURE TO NOTIFY AND COORDINATE WITH PROPERTY OWNERS AND/OR THE ENGINEER MAY RESULT IN DELAYS. NO ADDITIONAL COMPENSATION OR TIME FOR PERFORMANCE WILL BE GIVEN FOR ANY SUCH DELAYS.
- 2. CONTRACTOR SHALL, AT HIS EXPENSE, MAINTAIN THE WORK SITE IN A CLEAN AND ORDERLY APPEARANCE AT ALL TIMES. ALL DEBRIS AND SURPLUS MATERIAL COLLECTED SHALL BE DISPOSED OF OFF THE WORK SITE BY CONTRACTOR, AT HIS EXPENSE.
- EXISTING LAWNS, TREES, SHRUBS, FENCES, UTILITIES, CULVERTS, WALLS, WALKS, DRIVEWAYS, POLES, SIGNS, RIGHT-OF-WAY MONUMENTS, MAILBOXES AND THE LIKE SHALL BE PROTECTED FROM DAMAGE DURING THE WORK. ANY DAMAGE CAUSED TO SUCH ITEMS SHALL BE REPAIRED OR REPLACED BY CONTRACTOR AT NO ADDITIONAL COST. PROPERTY PINS DISTURBED BY CONTRACTOR THAT ARE NOT SHOWN ON THE PLANS TO BE DISTURBED SHALL BE RESTORED BY LICENSED SURVEYOR AT THE CONTRACTOR'S EXPENSE.
- 4. MEASURES TO CONTROL EROSION AND SILTATION SHALL BE PROVIDED PURSUANT TO AND IN COMPLIANCE WITH CURRENT FEDERAL, STATE AND LOCAL REGULATIONS. THE INFORMATION CONTAINED IN THE CONSTRUCTION PLANS AND/OR APPROVAL OF THE PLANS SHALL IN NO WAY RELIEVE THE CONTRACTOR OR HIS AGENT OF ANY LEGAL RESPONSIBILITY WHICH MAY BE REQUIRED BY THE CODE OF VIRGINIA OR ANY ORDINANCE ENACTED BY THE CITY OF CHARLOTTESVILLE. CONTRACTOR SHALL PROVIDE THE NECESSARY DIVERSION DITCHES, DIKES, OR TEMPORARY CULVERTS REQUIRED TO PREVENT MUD AND DEBRIS FROM BEING WASHED ONTO THE STREETS OR ADJACENT PROPERTY. CONTRACTOR'S VEHICLES SHALL BE KEPT CLEAN TO PREVENT MUD OR DUST FROM BEING DEPOSITED ON STREETS. NO AREA SHALL BE LEFT DENUDED FOR MORE THAN SEVEN (7) CALENDAR DAYS.
- 5. CONTRACTOR SHALL CLEAN UP, RESTORE, SEED AND MAINTAIN ALL DISTURBED AREAS IMMEDIATELY UPON COMPLETION OF WORK. TOPSOIL, SEED, FERTILIZER AND MULCH SHALL BE PLACED IN ACCORDANCE WITH CITY STANDARDS ON ALL DISTURBED AREAS. A PERMANENT STAND OF GRASS ADEQUATE TO PREVENT EROSION SHALL BE ESTABLISHED PRIOR TO FINAL ACCEPTANCE. ALL EROSION AND SEDIMENT CONTROLS SHALL BE REMOVED WITHIN 30 DAYS AFTER THE PROJECT IS STABILIZED. (MS-18)
- FOR FURTHER REQUIREMENTS AND DETAILS OF TREE PRESERVATION, PLANTING, EROSION AND SEDIMENT CONTROL HANDBOOK.
- 7. AN EROSION AND SEDIMENT CONTROL CONTRACTOR CERTIFICATION (E.S.C.C.C) IS REQUIRED FOR ALL LAND DISTURBANCE ACTIVITIES.
- 8. THE CONTRACTOR SHALL PROPERLY INSTALL AND MAINTAIN EROSION AND SEDIMENT CONTROLS FOR THE LIFE OF THE PROJECT; AND ROUTINELY CHECK CONTROL DEVICES BEFORE, DURING AND AFTER STORM EVENTS.

INCIDENTAL NOTES

- 1. CLEARING AND GRUBBING SHALL BE CONFINED TO THOSE AREAS NEEDED FOR CONSTRUCTION.
- 2. DISTURBED AREAS BEYOND THE ROADWAY CURB AND WHERE INDICATED ON THE PLANS SHALL RECEIVE TOPSOIL AS NECESSARY AND AS DIRECTED. SEEDING MIXTURE SHALL BE DETERMINED BY THE VIRGINIA EROSION AND SEDIMENT CONTROL HANDBOOK, SECTION 3.32

VEGETATION

1. TREE AND PLANT ROOTS OR BRANCHES THAT MAY INTERFERE WITH THE WORK SHALL BE TRIMMED OR CUT ONLY WITH THE APPROVAL OF THE OWNER AND ENGINEER. ANY TREES OR PLANTS WHICH ARE SHOWN TO REMAIN THAT DO NOT INTERFERE WITH THE WORK, BUT ARE DAMAGED BY CONTRACTOR OR HIS SUB-CONTRATORS, SHALL BE REPLACED BY CONTRACTOR AT NO ADDITIONAL COST.

EARTH WORK AND SITE CONDITIONS

- 1. EXCEPT AS OTHERWISE SHOWN ON THE PLANS, ALL CUTS AND FILLS SHALL MATCH EXISTING SLOPES OR BE NO GREATER THAN 4:1.
- 2. UNLESS OTHERWISE NOTED ON THE PLANS OR IN THE SPECIFICATIONS, ALL FILL MATERIALS SHALL BE COMPACTED TO 95% OF THEORETICAL MAXIMUM DENSITY AS DETERMINED BY AASHTO T-99 METHOD A, WITHIN PLUS OR MINUS 2% OF OPTIMUM MOISTURE, FOR THE FULL WIDTH AND THE DEPTH OF THE FILL.
- 3. ALL GRADING AND IMPROVEMENTS TO BE CONFINED TO THE PROJECT AREA UNLESS
- 4. PROPOSED GRADES SHALL BE FIELD ADJUSTED TO CONFORM TO THE INTENT OF THE TYPICAL SECTIONS. A SMOOTH GRADE SHALL BE MAINTAINED FOR THE BASELINE TO THE PROPOSED EDGE OF PAVEMENT OR FACE OF CURB TO PRECLUDE THE FORMING OF FALSE GUTTERS AND/OR PONDING OF WATER ON ALL PAVED SURFACES.
- 5. ALL MATERIALS AND INSTALLATION DETAILS SHALL CONFORM TO THE CITY OF CHARLOTTESVILLE ENGINEERING DIVISION STANDARDS AND ALL OTHER APPLICABLE CITY ORDINANCES
- ANY UNUSUAL OR UNANTICIPATED SUBSURFACE CONDITIONS SHALL BE IMMEDIATELY REPORTED TO THE ENGINEER.
- 7. CONTRACTOR SHALL VERIFY ALL DIMENSIONS, ELEVATIONS AND LOCATIONS PRIOR TO BEGINNING WORK, AND IMMEDIATELY NOTIFY THE ENGINEER IN THE EVENT THERE ARE ANY DISCREPANCIES BETWEEN SUCH CONDITIONS AND THOSE SHOWN ON THE PLANS AND SPECIFICATIONS.

CONCRETE AND ASPHALT

- 1. ALL MATERIAL INSIDE FORMS SHALL BE CLEAN AND FREE OF ALL ROCKS AND OTHER LOOSE DEBRIS. SUB-BASE MATERIAL SHALL BE COMPACTED BY MECHANICAL MEANS.
- 4. CONCRETE SHALL NOT BE PLACED UNLESS THE AIR TEMPERATURE IS AT LEAST 40 DEGREES FAHRENHEIT (F) IN THE SHADE AND RISING.
- 5. CONCRETE SHALL NOT BE PLACED UNTIL STEEL DOWELS HAVE BEEN INSTALLED IN EXISTING CONCRETE IN ACCORDANCE WITH CITY STANDARDS.
- 6. 1/2" PREMOLDED EXPANSION JOINT MATERIAL SHALL BE PLACED AT A MAXIMUM OF 30' INTERVALS ON NEW SIDEWALK, CURB, CURB & GUTTER, AT EACH END OF DRIVEWAY ENTRANCES, AT EACH END OF HANDICAP RAMPS, SOME POINT ON ENTRANCE WALKS AND STEPS ADJUSTMENTS, AND ALONG BUILDINGS AND WALLS WHERE NEW CONCRETE SIDEWALKS ARE PLACED AGAINST THEM.
- 7. ALL EXISTING CURBS, CURB & GUTTER, SIDEWALK AND STEPS TO BE REMOVED SHALL BE TAKEN OUT TO THE NEAREST JOINT. DEMOLITION AND DISPOSAL COST TO BE INCLUDED IN OTHER UNIT BID ITEMS. NO SEPARATE PAYMENT WILL BE MADE FOR THIS WORK.
- 8. EXISTING ASPHALT CONCRETE PAVEMENT SHALL BE SAW CUT AND REMOVED AS PER THE SPECIFICATIONS. REMOVAL SHALL BE DONE IN SUCH A MANNER AS TO NOT TEAR, BULGE OR DISPLACE ADJACENT PAVEMENT. EDGES SHALL BE CLEAN AND VERTICAL, ALL CUTS SHALL BE PARALLEL OR PERPENDICULAR TO THE DIRECTION OF TRAFFIC.
- DISPOSAL OF ALL EXCESS AND DEMOLITION MATERIAL IS THE RESPONSIBILITY OF THE CONTRACTOR.

DRAINAGE

- CONTRACTOR SHALL EXERCISE CARE, ESPECIALLY AT INTERSECTIONS AND GUTTER LINES, TO
 PROVIDE POSITIVE DRAINAGE. ANY AREAS WHERE WATER IS IMPOUNDED SHALL BE
 CORRECTED BY CONTRACTOR AT NO ADDITIONAL COST. POSITIVE DRAINAGE OF ALL ROADWAY
 AREAS TO THE STORM DRAIN INLETS OR OTHER ACCEPTABLE DRAINAGE CHANNELS AS NOTED
 ON THE PLANS IS REQUIRED.
- CONTRACTOR SHALL MAINTAIN EXISTING STREAMS, DITCHES, DRAINAGE STRUCTURES, CULVERT AND FLOWS AT ALL TIMES DURING THE WORK. CONTRACTOR SHALL PAY FOR ALL PERSONAL INJURY AND PROPERTY DAMAGE WHICH MAY OCCUR AS A RESULT OF FAILING TO MAINTAIN ADEQUATE DRAINAGE.
- 3. ALL PIPES, DI'S AND OTHER STRUCTURES SHALL BE INSPECTED BY THE ENGINEER BEFORE BEING BACKFILLED OR BURIED. THE ENGINEER MAY REQUIRE CONTRACTOR, AT NO ADDITIONAL COST, TO UNCOVER AND RE-COVER SUCH STRUCTURES IF THE HAVE BEEN BACKFILLED OR BURIED WITHOUT SUCH INSPECTION.

GENERAL NOTES FOR MAINTENANCE OF TRAFFIC

- 1. THE VIRGINIA WORK AREA PROTECTION MANUAL AND THE MANUAL ON UNIFORM TRAFFIC CONTROL DEVICES (MUTCD) SHALL GOVERN ALL TEMPORARY TRAFFIC CONTROL OPERATIONS THROUGHOUT CONSTRUCTION OF THIS PROJECT. ADHERENCE TO APPLICABLE PROVISIONS OF THE MANUAL IS REQUIRED OF THE CONTRACTOR EVEN THOUGH DETAILED REFERENCE TO ALL SUCH PROVISIONS MAY NOT BE CONTAINED IN THE PLANS.
- 2. ALL EXISTING RESIDENTIAL AND COMMERCIAL ENTRANCES SHALL BE MAINTAINED AT ALL TIMES, UNLESS OTHERWISE DIRECTED BY THE ENGINEER.
- 3. NO TEMPORARY PAVEMENT MARKING SHALL BE ALLOWED ON THE FINAL ASPHALT SURFACE
- 4. THE CONTRACTOR SHALL MAINTAIN ALL LANES OF TRAVEL OPEN FROM 6:30 AM TO 9:00 AM AND 3:00 PM TO 5:00 PM UNLESS DEEMED UNNECESSARY BY THE ENGINEER. SHORT PERIODS OF ONE WAY FLAGGING OPERATIONS MAY BE CONDUCTED OUTSIDE THE HOURS MENTIONED ABOVE.
- 5. ALL TRAFFIC SIGNALS SHALL BE ADJUSTED BY THE ENGINEER AS DEEMED NECESSARY BY THE ENGINEER PRIOR TO ANY TRAFFIC CHANGES.
- 6. WHEN WORK IN THE EXCAVATION AREA IS DISCONTINUED FOR A SHORT PERIOD OF TIME, AS AT NIGHT, THE CONTRACTOR SHALL BACKFILL THE CUT AREAS ADJACENT TO THE EXISTING PAVEMENT WITH A 'FILLET OF MATERIAL'. THE FILLET SHALL BE COMPOSED OF THE SAME MATERIAL (EXCAVATION, BORROW, BASE COURSE, ETC.) ALL COSTS FOR PLACING AND REMOVING THIS FILLET OF MATERIAL SHALL BE INCLUDED IN THE PRICE BID FOR OTHER BID ITEMS OF WORK ON THIS PROJECT, AND NO ADDITIONAL CHARGE WILL BE ALLOWED.
- 7. EXISTING SURFACE, AGGREGATE BASE AND SUBBASE MATERIAL WHICH WILL BE DEMOLISHED OR OBLITERATED DURING CONSTRUCTION AND WHICH IS SUITABLE FOR MAINTENANCE OF TRAFFIC AS DETERMINED BY THE ENGINEER, SHALL BE SALVAGED AND UTILIZED FOR MAINTENANCE OF TRAFFIC PRIOR TO THE USE OF COMMERCIAL MATERIAL. WHEN NOT SPECIFIED AS A SEPARATE PAY ITEM, THE REMOVAL AND SALVAGING OF EXISTING SURFACES AND AGGREGATE BASE AND SUBBASE MATERIAL WILL BE MEASURED AND PAID FOR AS REGULAR EXCAVATION IN ACCORDANCE WITH SECTION 303 OF THE SPECIFICATIONS.
- 8. CONSTRUCT ALL INTERSECTIONS AND DRIVEWAYS UNDER TRAFFIC.
- 9. TEMPORARY TRAFFIC BARRIER SERVICE SHALL BE INSTALLED AND REMOVED SO AS NOT TO PRESENT ANY BLUNT END OR HAZARD TO THE MOTORING PUBLIC.
- 10. CONTRACTOR SHALL NOTIFY TRANSIT PROVIDERS A MINIMUM OF TWO WEEKS PRIOR TO ANY IMPACT OR DISRUPTION TO REGULAR SERVICE OR STOPS.
- 11. ALL EXISTING PAVEMENT MARKINGS CONFLICTING WITH PROPOSED CONSTRUCTION PAVEMENT MARKINGS SHALL BE ERADICATED.
- 12. INSTALLATION AND REMOVAL OF TEMPORARY TRAFFIC CONTROL DEVICES SHALL BE IN ACCORDANCE WITH THE SECTION 6G.25 OF THE WORK AREA PROTECTION MANUAL.
- 13. USE APPROPRIATE SIGNS TO SHIFT PEDESTRIAN TRAFFIC AS NEEDED.
- 14. CONTRACTOR SHALL ASSURE ENDS OF TEMPORARY CONCRETE BARRIER DO NOT OBSTURCT INTERSECTION SIGHT LINES.

SUGGESTED SEQUENCE OF CONSTRUCTION (SEE SHEET C1.1)

PHASE 1

1A-SHIFT CHERRY AVENUE TRAFFIC TO THE SOUTH APPROXIMATELY 6 FEET. MAINTAIN ONE THROUGH TRAVEL LANE IN EACH DIRECTION AND LEFT TURN LANES AT 7 ½ STREET AND JUST WEST OF 5TH STREET. ALL TRAVEL LANES SHALL BE A MINIMUM OF 10 FEET. MAINTAIN PEDESTRIAN TRAFFIC ALONG CHERRY AVENUE ON THE SOUTHERN SIDEWALK.

1B- PROVIDE PHASE 1 CHANNELIZING DEVICES AND CONSTRUCTION SIGNING.

1C-INSTALL PHASE 1 EROSION AND SEDIMENT CONTROL DEVICES, AND CONSTRUCT THE CURB AND SIDEWALK CHANGES ALONG THE NORTH SIDE OF CHERRY AVENUE.

PHASE 2

2A-SHIFT CHERRY AVENUE TRAFFIC TO THE NORTH APPROXIMATELY 6 FEET FROM THE EXISTING CURB LINE AT THE 7 ½ STREET INTERSECTION AND THE NEW CURB LINE FROM 6 ½ TO 6TH STREETS.

MAINTAIN ONE THROUGH TRAVEL LANE IN EACH DIRECTION AND LEFT TURN LANES AT 7 ½ STREET.

ALL TRAVEL LANES SHALL BE A MINIMUM OF 10 FEET. MAINTAIN PEDESTRIAN TRAFFIC ALONG CHERRY AVENUE ON THE NORTHERN SIDEWALK.

2B- PROVIDE PHASE 2 CHANNELIZING DEVICES AND CONSTRUCTION SIGNING.

2C - INSTALL PHASE 2 EROSION AND SEDIMENT CONTROL DEVICES, AND CONSTRUCT THE CURB AND SIDEWALK CHANGES ALONG THE NORTH SIDE OF CHERRY AVENUE.

PHASE 3

COMPLETE CONSTRUCTION INCLUDING NEW PAVEMENT FINAL SURFACE COURSE, REMAINING, LANDSCAPE/STREETCAPE FEATURES, SIGNING, PAVEMENT MARKINGS, AND RAPID FLASH BEACONS.



CHERRY AVENUE
7-1/2 STREET SW TO 6TH STREET SN

PREPARED: EL/JD/MK

CHECKED: EM/MAB

04/28/14

REV 1 - REV . 2 -


REV.3 -

SHEET NAME
GENERAL NOTES &
SEQUENCE OF
CONSTRUCTION
DRAWING NUMBER

C1.0

SHEET NUMBER

02 of 22

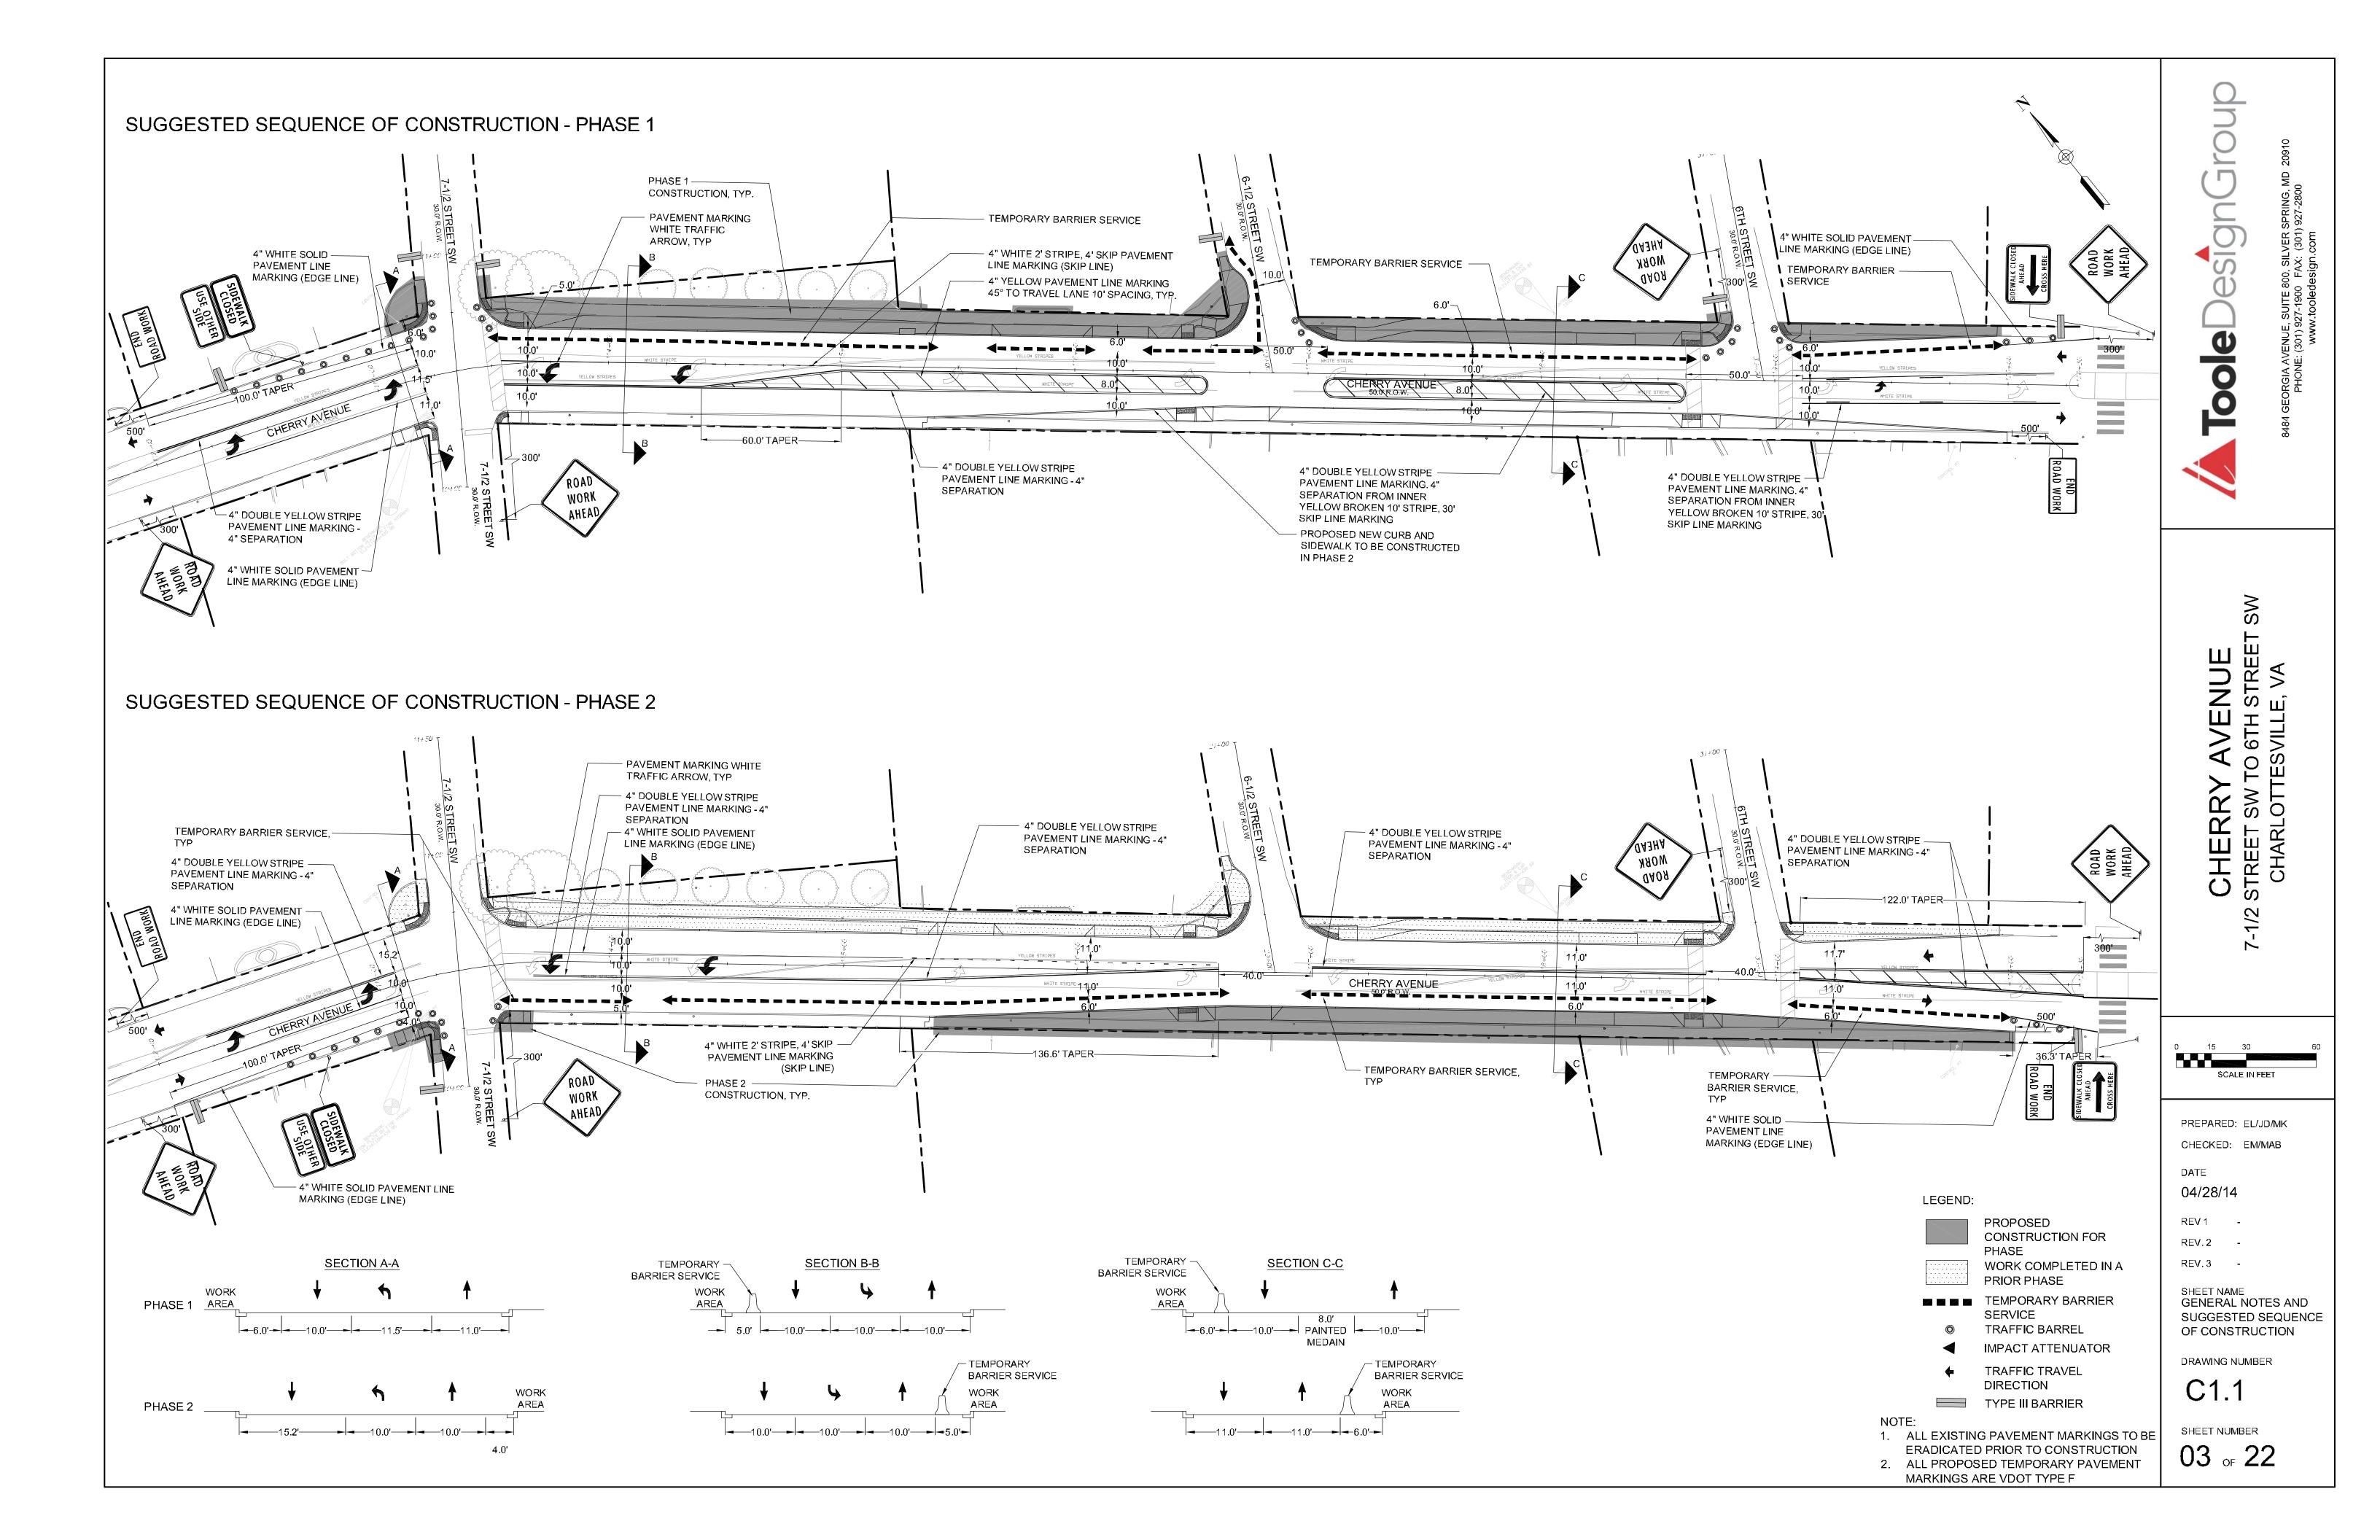

DATE 04/28/14

REV 1 -


REV.2 -REV.3 -

SHEET NAME TYPICAL SECTIONS


DRAWING NUMBER


C2.0

SHEET NUMBER 04 of 22

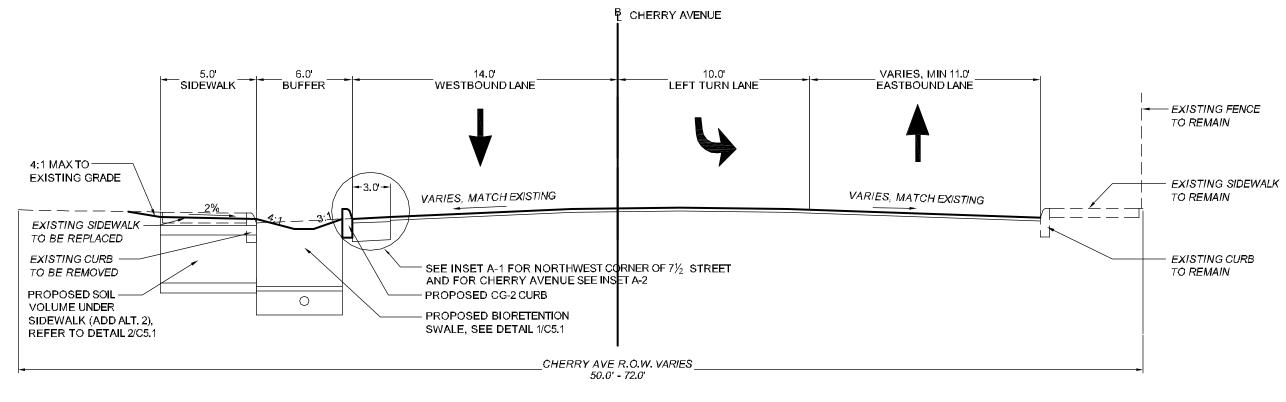


TYPICAL SECTION STA. 113+65 TO 115+40 SCALE: 1" = 5'-0"

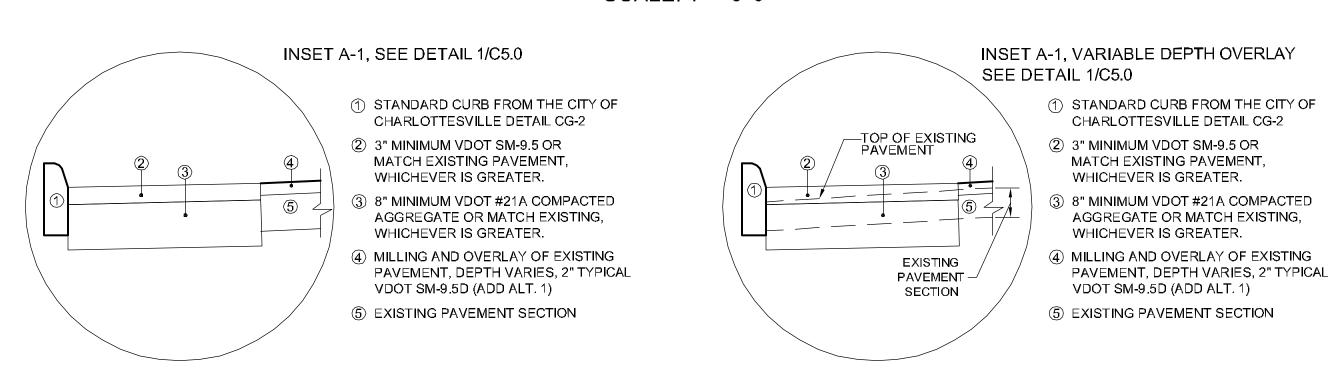


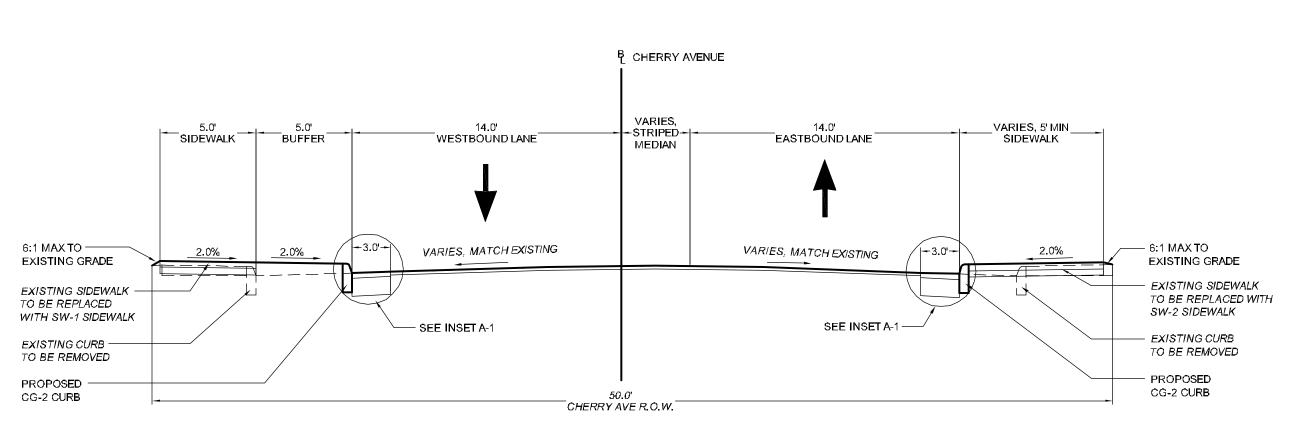

TYPICAL SECTION STA. 115+40 TO 116+75 SCALE: 1" = 5'-0"

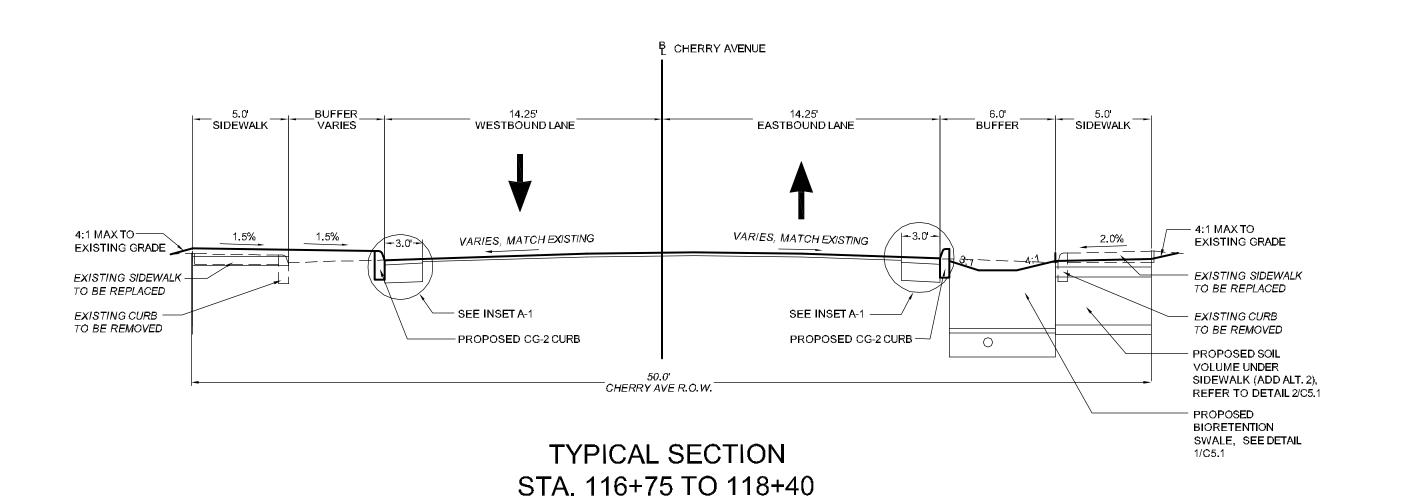

SCALE: 1" = 5'-0"

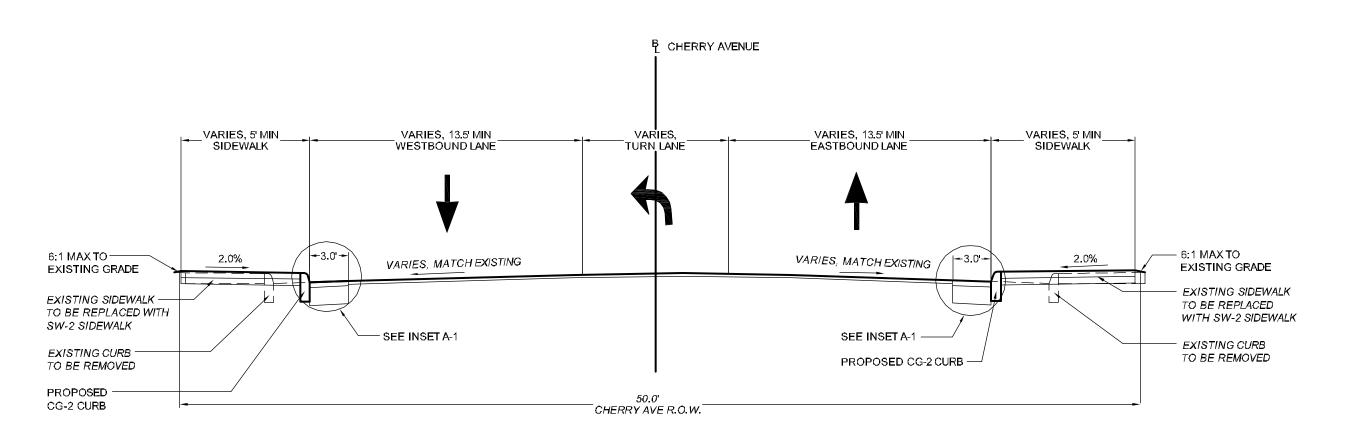

TYPICAL SECTION STA. 118+40 TO 120+20 SCALE: 1" = 5'-0"

SIQ ole

PREPARED: EL/JD/MK CHECKED: EM/MAB

04/28/14

REV 1 -REV 2

REV 3

SHEET NAME DEMOLITION AND **EROSION AND SEDIMENT**

CONTROL PLANS DRAWING NUMBER

C3.0

SHEET NUMBER

SoleDesignGroup

CHERRY AVENUE
STREET SW TO 6TH STREET SW

0 05 10

SCALE IN FEET

PREPARED: EL/JD/MK CHECKED: EM/MAB

DATE 04/28/14

REV.2 -

REV.3 -

SHEET NAME

DEMOLITION AND

EROSION AND SEDIMENT


CONTROL PLANS

DRAWING NUMBER

C3.1

SHEET NUMBER

06 OF 22

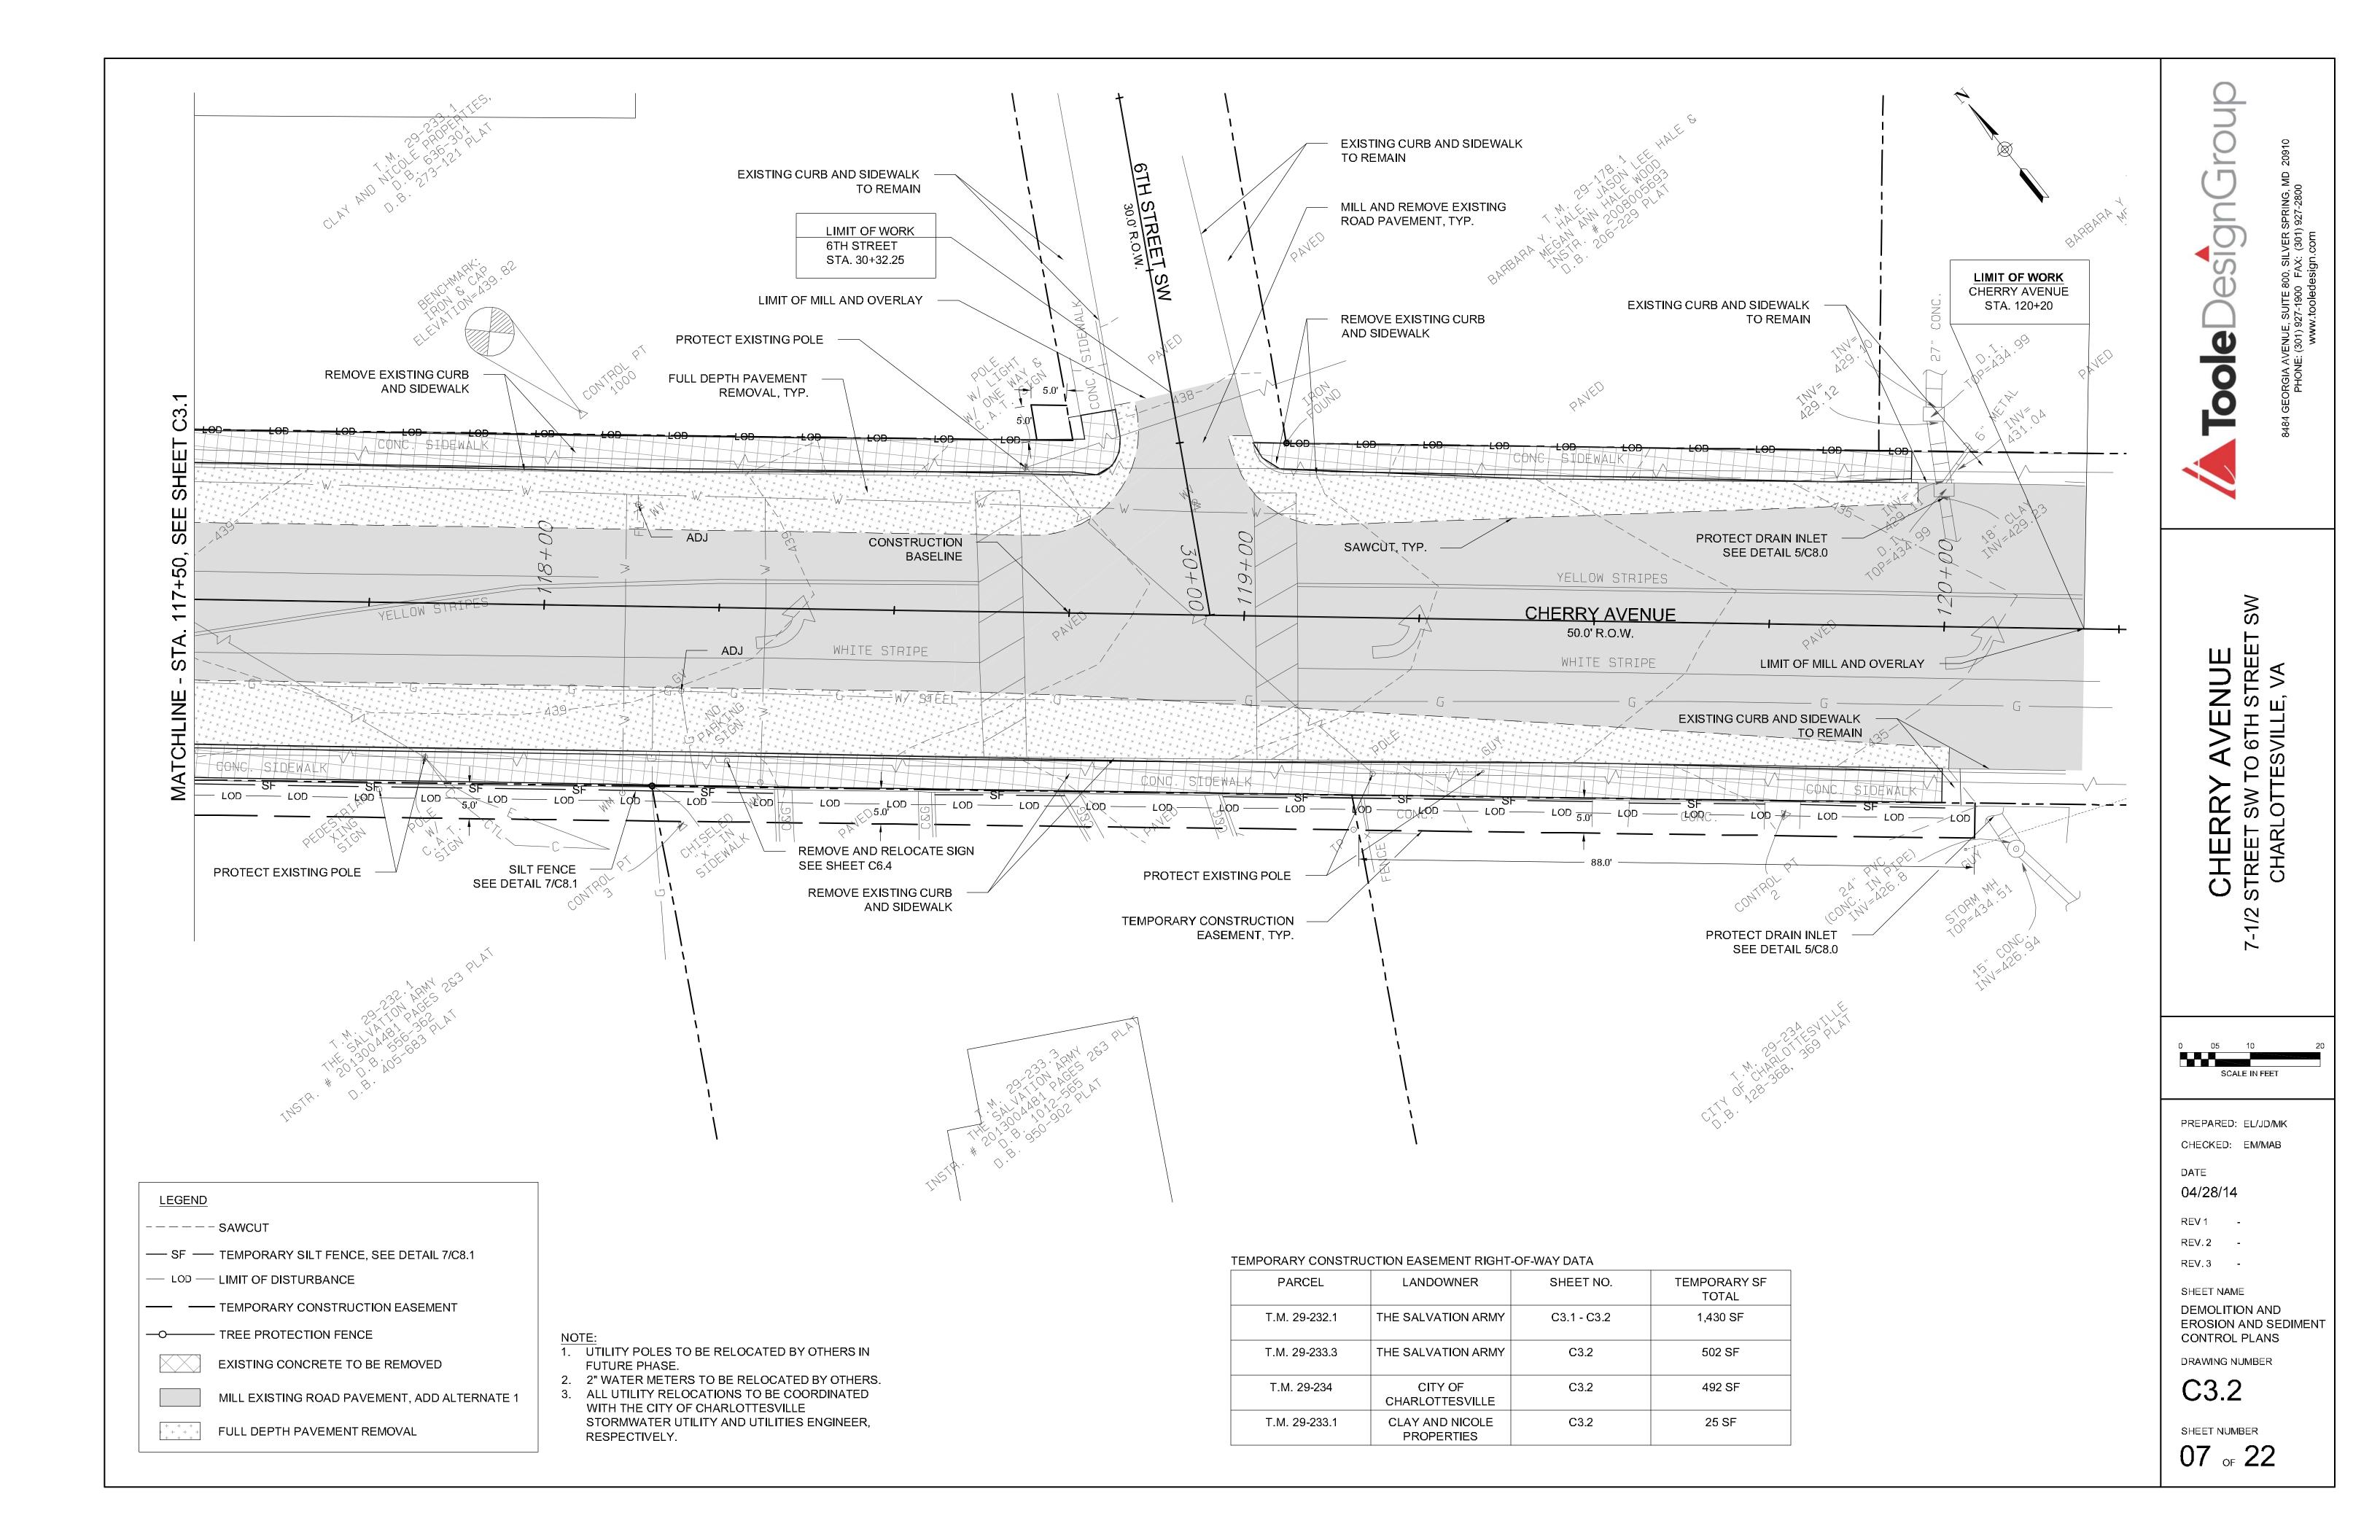

 STATIONS AND OFFSETS SHOWN ARE TO FACE OF CURB OR EDGE OF SIDEWALK UNLESS OTHERWISE NOTED.

7-1/2 STREET CONSTRUCTION & DATA

DESCRIPTION	TANGENT / CURVE DATA	NORTHING	EASTING
STA 10+00	N 33°47'20.02" E	3897923.61	11485052.73
STA 11+50.00	L = 150.00'	3898048.27	11485136.15

SURVEY CONTROL POINTS

POINT	NORTHING	EASTING	DESCRIPTION	ELEVATION
5	3897997.41	11485073.94	NAIL	
3385	3897957.01	11485050.59	BOLT ON BOTTOM PLATE OF FIRE HYDRANT	439.95

esignGrou

Toole

8484 GEORGIA AVENUE, SUITE 800, SILVER SPRING, N PHONE: (301) 927-1900 FAX: (301) 927-2800

CHERRY AVENUE
7-1/2 STREET SW TO 6TH STREET SCHARLOTTESVILLE, VA

0 05 10 SCALE IN FEET

PREPARED: EL/JD/MK
CHECKED: EM/MAB

DATE 04/28/14

REV1 -

REV.3 -

SHEET NAME


GEOMETRIC PLAN

DRAWING NUMBER

C4.0

SHEET NUMBER

08 OF 22

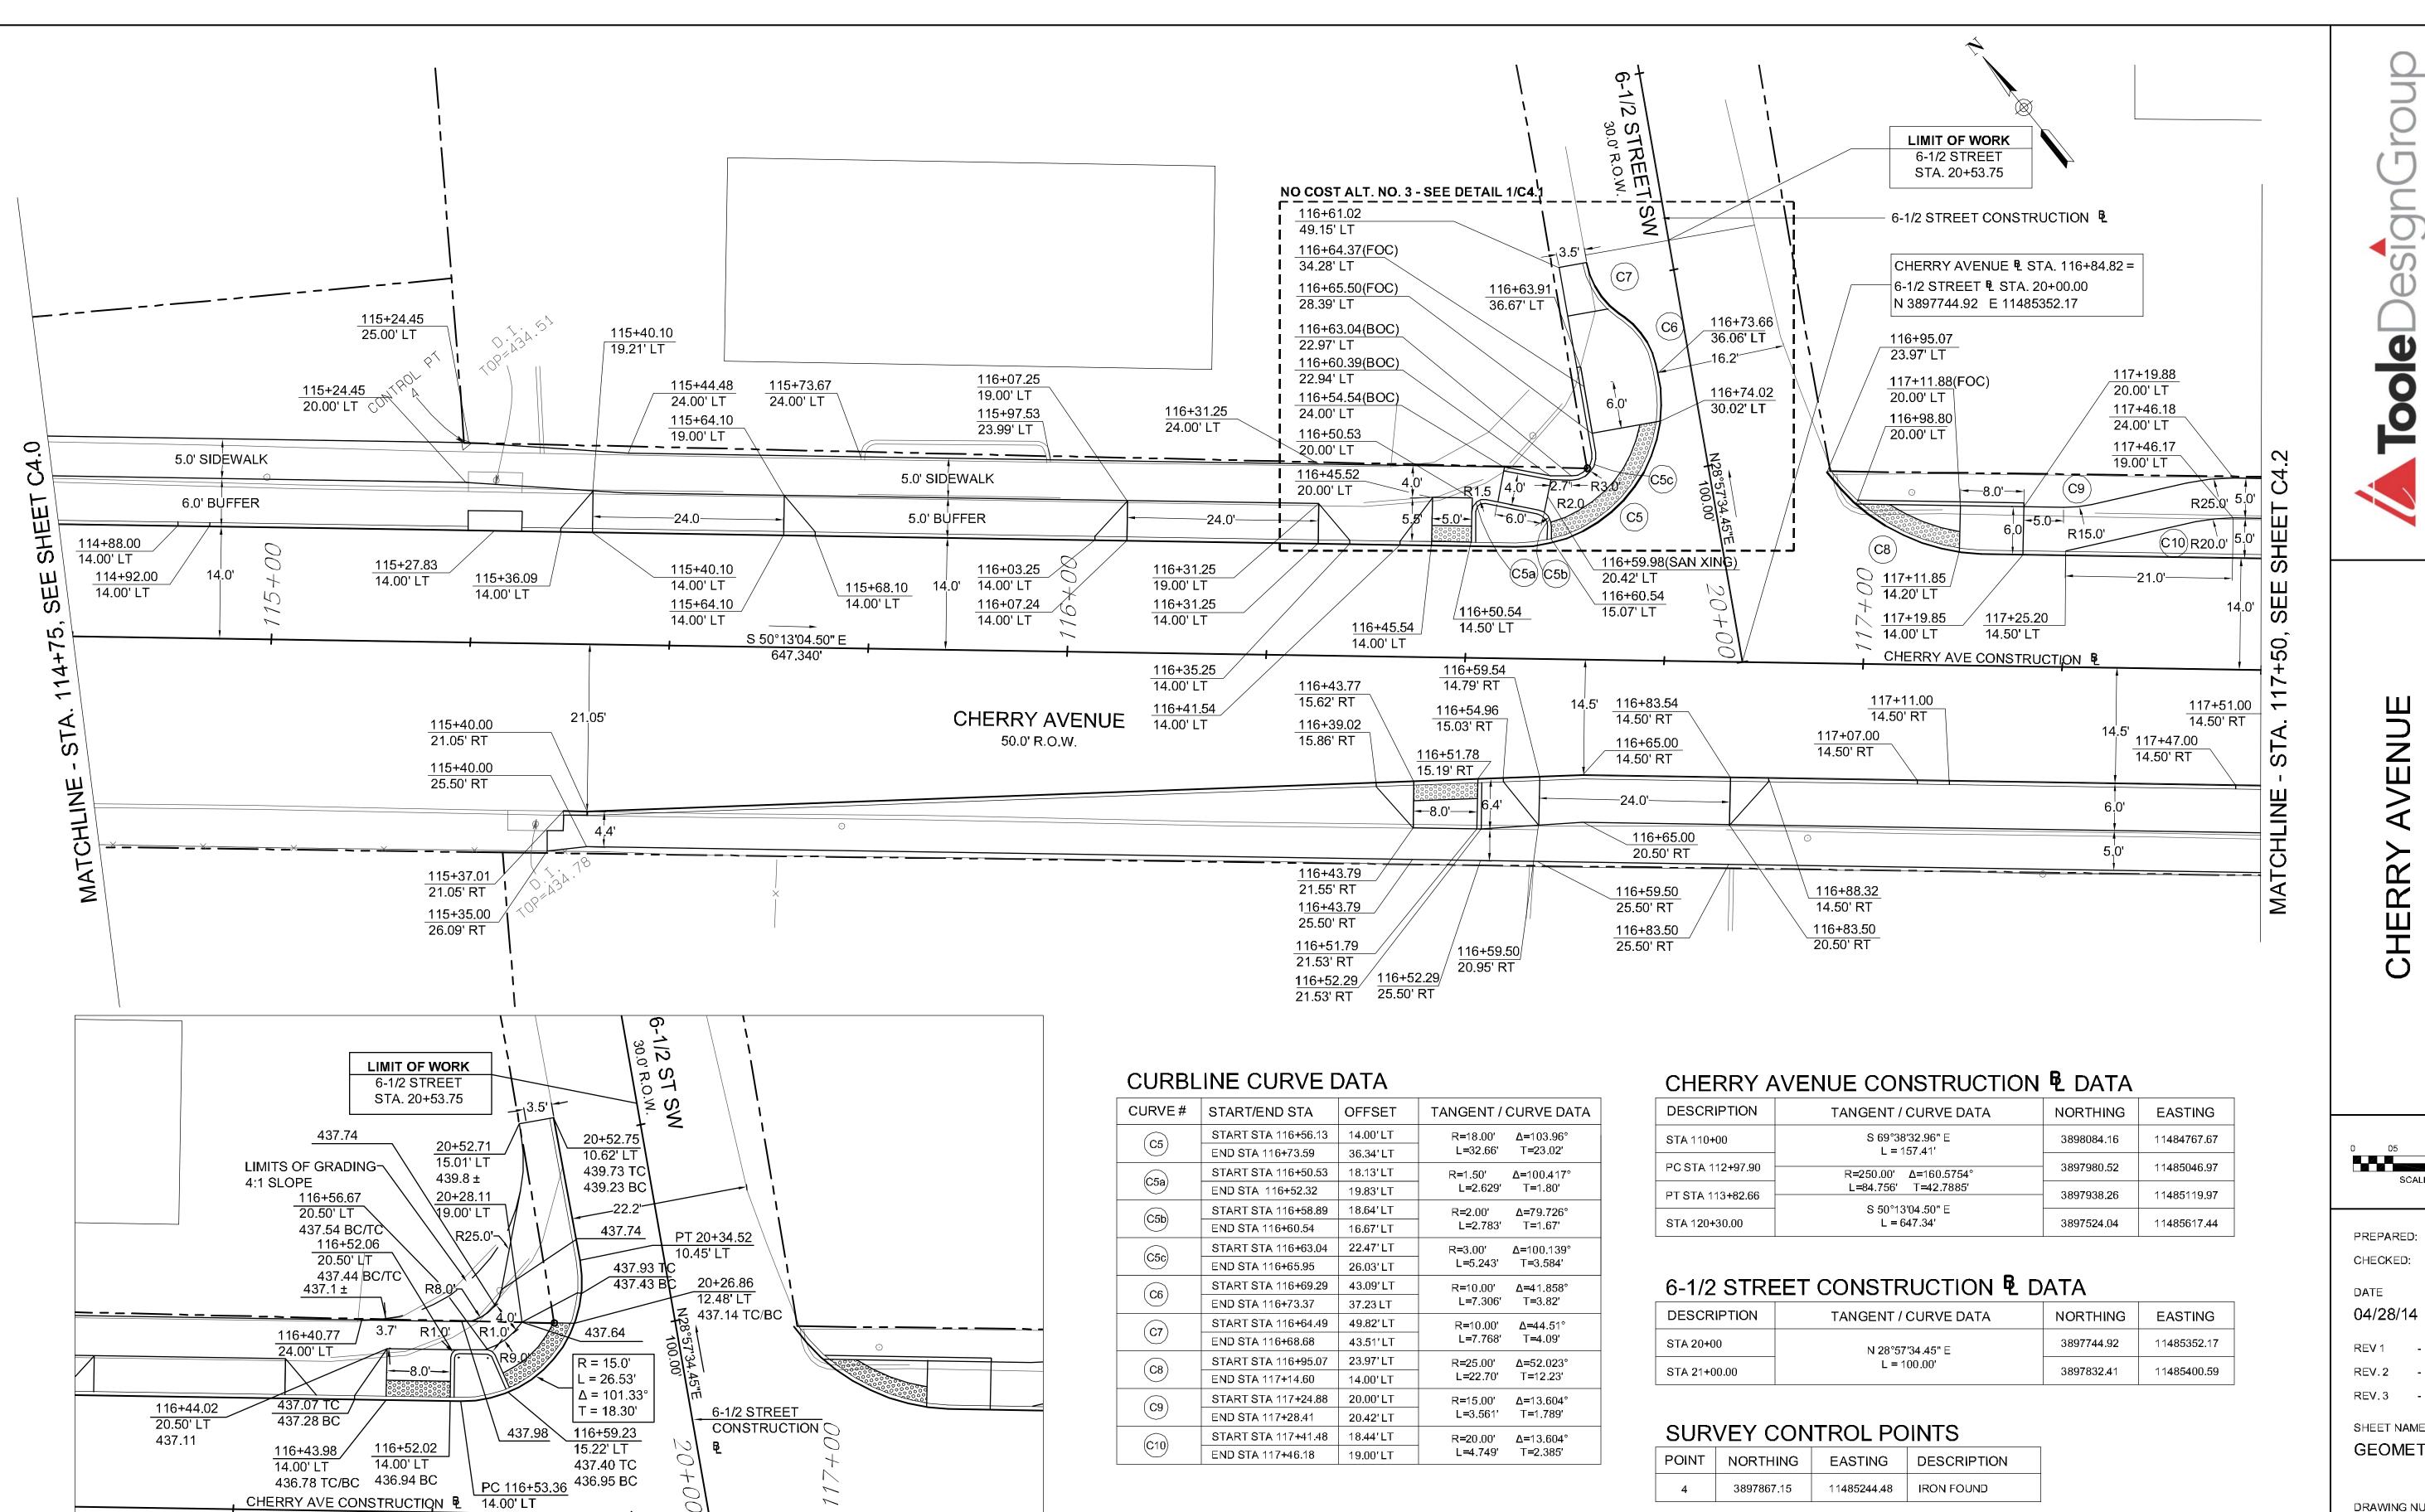

NO COST ALT. NO. 3 - NW CORNER OF 6-1/2 ST. AND CHERRY AVE. INTERSECTION

SCALE: 1' = 10'-0"

ole 0

VENUE 6TH STREE VILLE, VA

PREPARED: EL/JD/MK CHECKED: EM/MAB

04/28/14

REV1 -REV.2 -

SHEET NAME GEOMETRIC PLAN

DRAWING NUMBER


C4.1

1. STATIONS AND OFFSETS SHOWN ARE TO FACE OF

CURB OR EDGE OF SIDEWALK UNLESS OTHERWISE

SHEET NUMBER

09 of 22

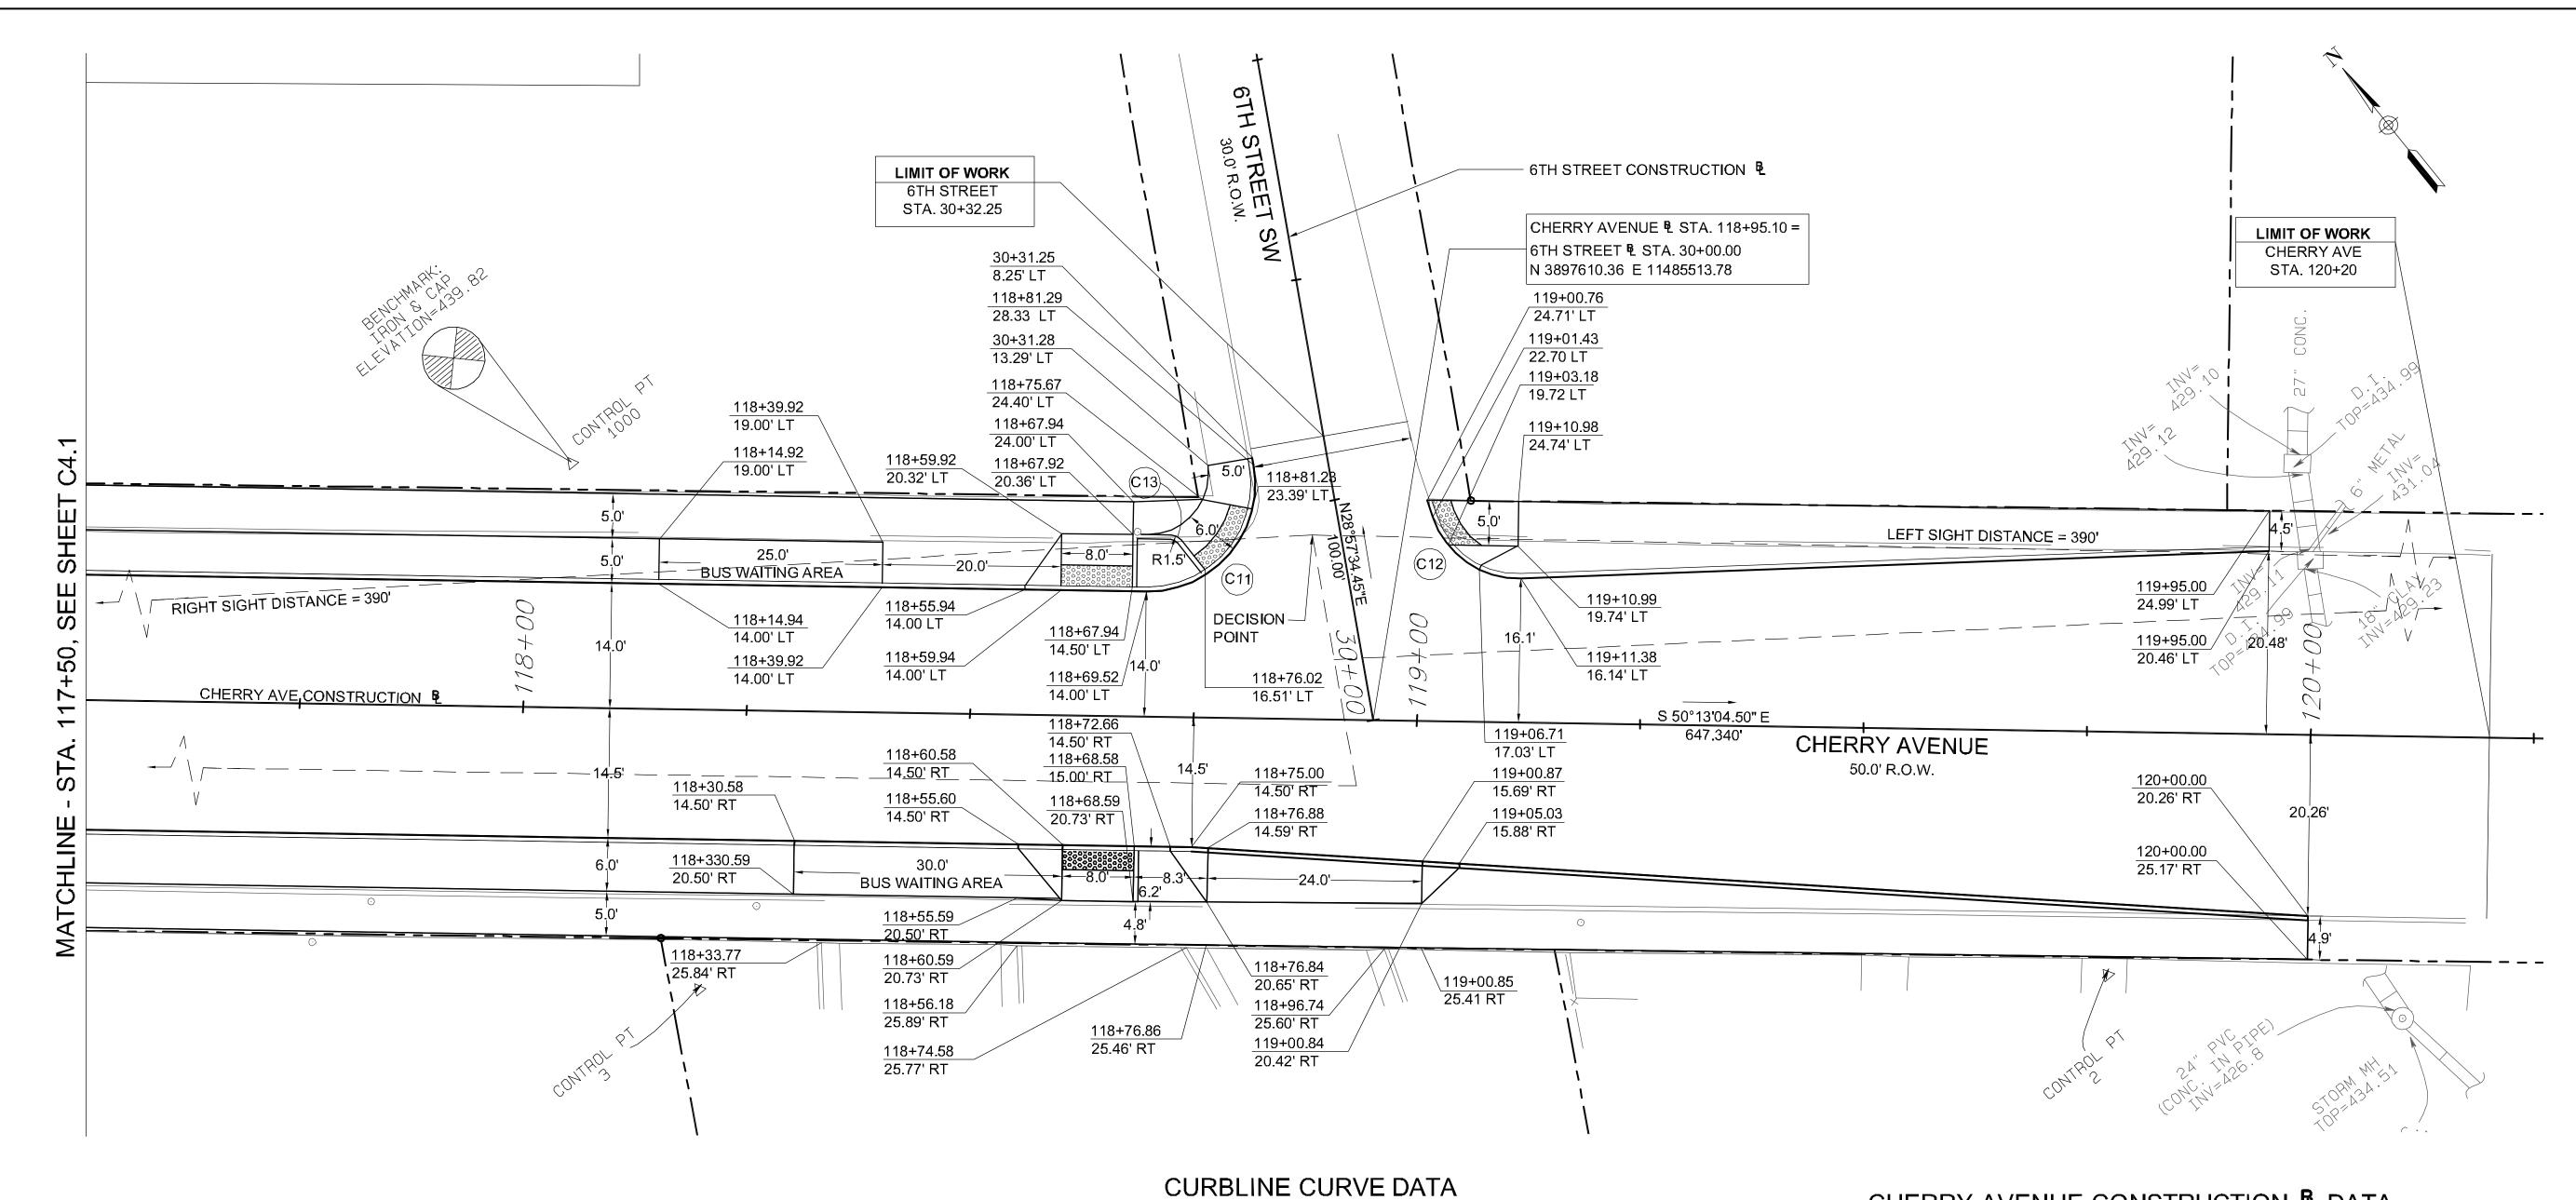

CURVE#	START/END STA	OFFSET	TANGENT / CURVE DATA
(C11)	START STA 118+69.52	14.00' LT	R=12.00' Δ=101.197°
(C11)	END STA 118+81.29	28.33' LT	L=21.195' T=14.61'
(C12)	START STA 119+01.43	22.80' LT	R=10.00' Δ=73.524°
012	END STA 119+11.38	16.14'LT	L=12.832' T=7.47'
(C13)	START STA 118+72.16	20.37'LT	R=1.50' Δ=51.09°
013	END STA 118+73.33	19.82' LT	L=1.338' T=0.717'

CHERRY AVENUE CONSTRUCTION & DATA

DESCRIPTION	TANGENT / CURVE DATA	NORTHING	EASTING
STA 110+00	S 69°38'32.96" E L = 157.41'	3898084.16	11484767.67
PC STA 112+97.90	R=250.00' Δ=160.5754°	3897980.52	11485046.97
PT STA 113+82.66	L=84.756' T=42.7885'	3897938.26	11485119.97
STA 120+30.00	S 50°13'04.50" E L = 647.34'	3897524.04	11485617.44

6TH STREET CONSTRUCTION € DATA

• · · · · • · · · · · ·			
DESCRIPTION	TANGENT / CURVE DATA	NORTHING	EASTING
STA 30+00	N 28°57'34.45" E	3897610.36	11485513.78
STA 31+00.00	L = 100.00'	3897697.86	11485562.19

SURVEY CONTROL POINTS

POINT	NORTHING	EASTING	DESCRIPTION	ELEVATION
2	3897536.78	11485559.81	IRON AND CAP	
3	3897634.45	11485436.15	NAIL	
1000	3897689.22	11485462.04	IRON AND CAP	439.82

 STATIONS AND OFFSETS SHOWN ARE TO FACE OF CURB OR EDGE OF SIDEWALK UNLESS OTHERWISE NOTED.

Toole

PREPARED: EL/JD/MK CHECKED: EM/MAB

04/28/14

REV.3 -

SHEET NAME GEOMETRIC PLAN

DRAWING NUMBER

C4.2

SHEET NUMBER 10 of 22

TooleDesignGroup

CHERRY AVENUE
7-1/2 STREET SW TO 6TH STREET SN
CHARLOTTESVILLE, VA

0 05 10

SCALE IN FEET

PREPARED: EL/JD/MK
CHECKED: EM/MAB

04/28/14

REV 1 - REV. 2 -

SHEET NAME


PAVING AND

PAVING AND GRADING PLAN

DRAWING NUMBER

C5.0

sheet number 11 of 22

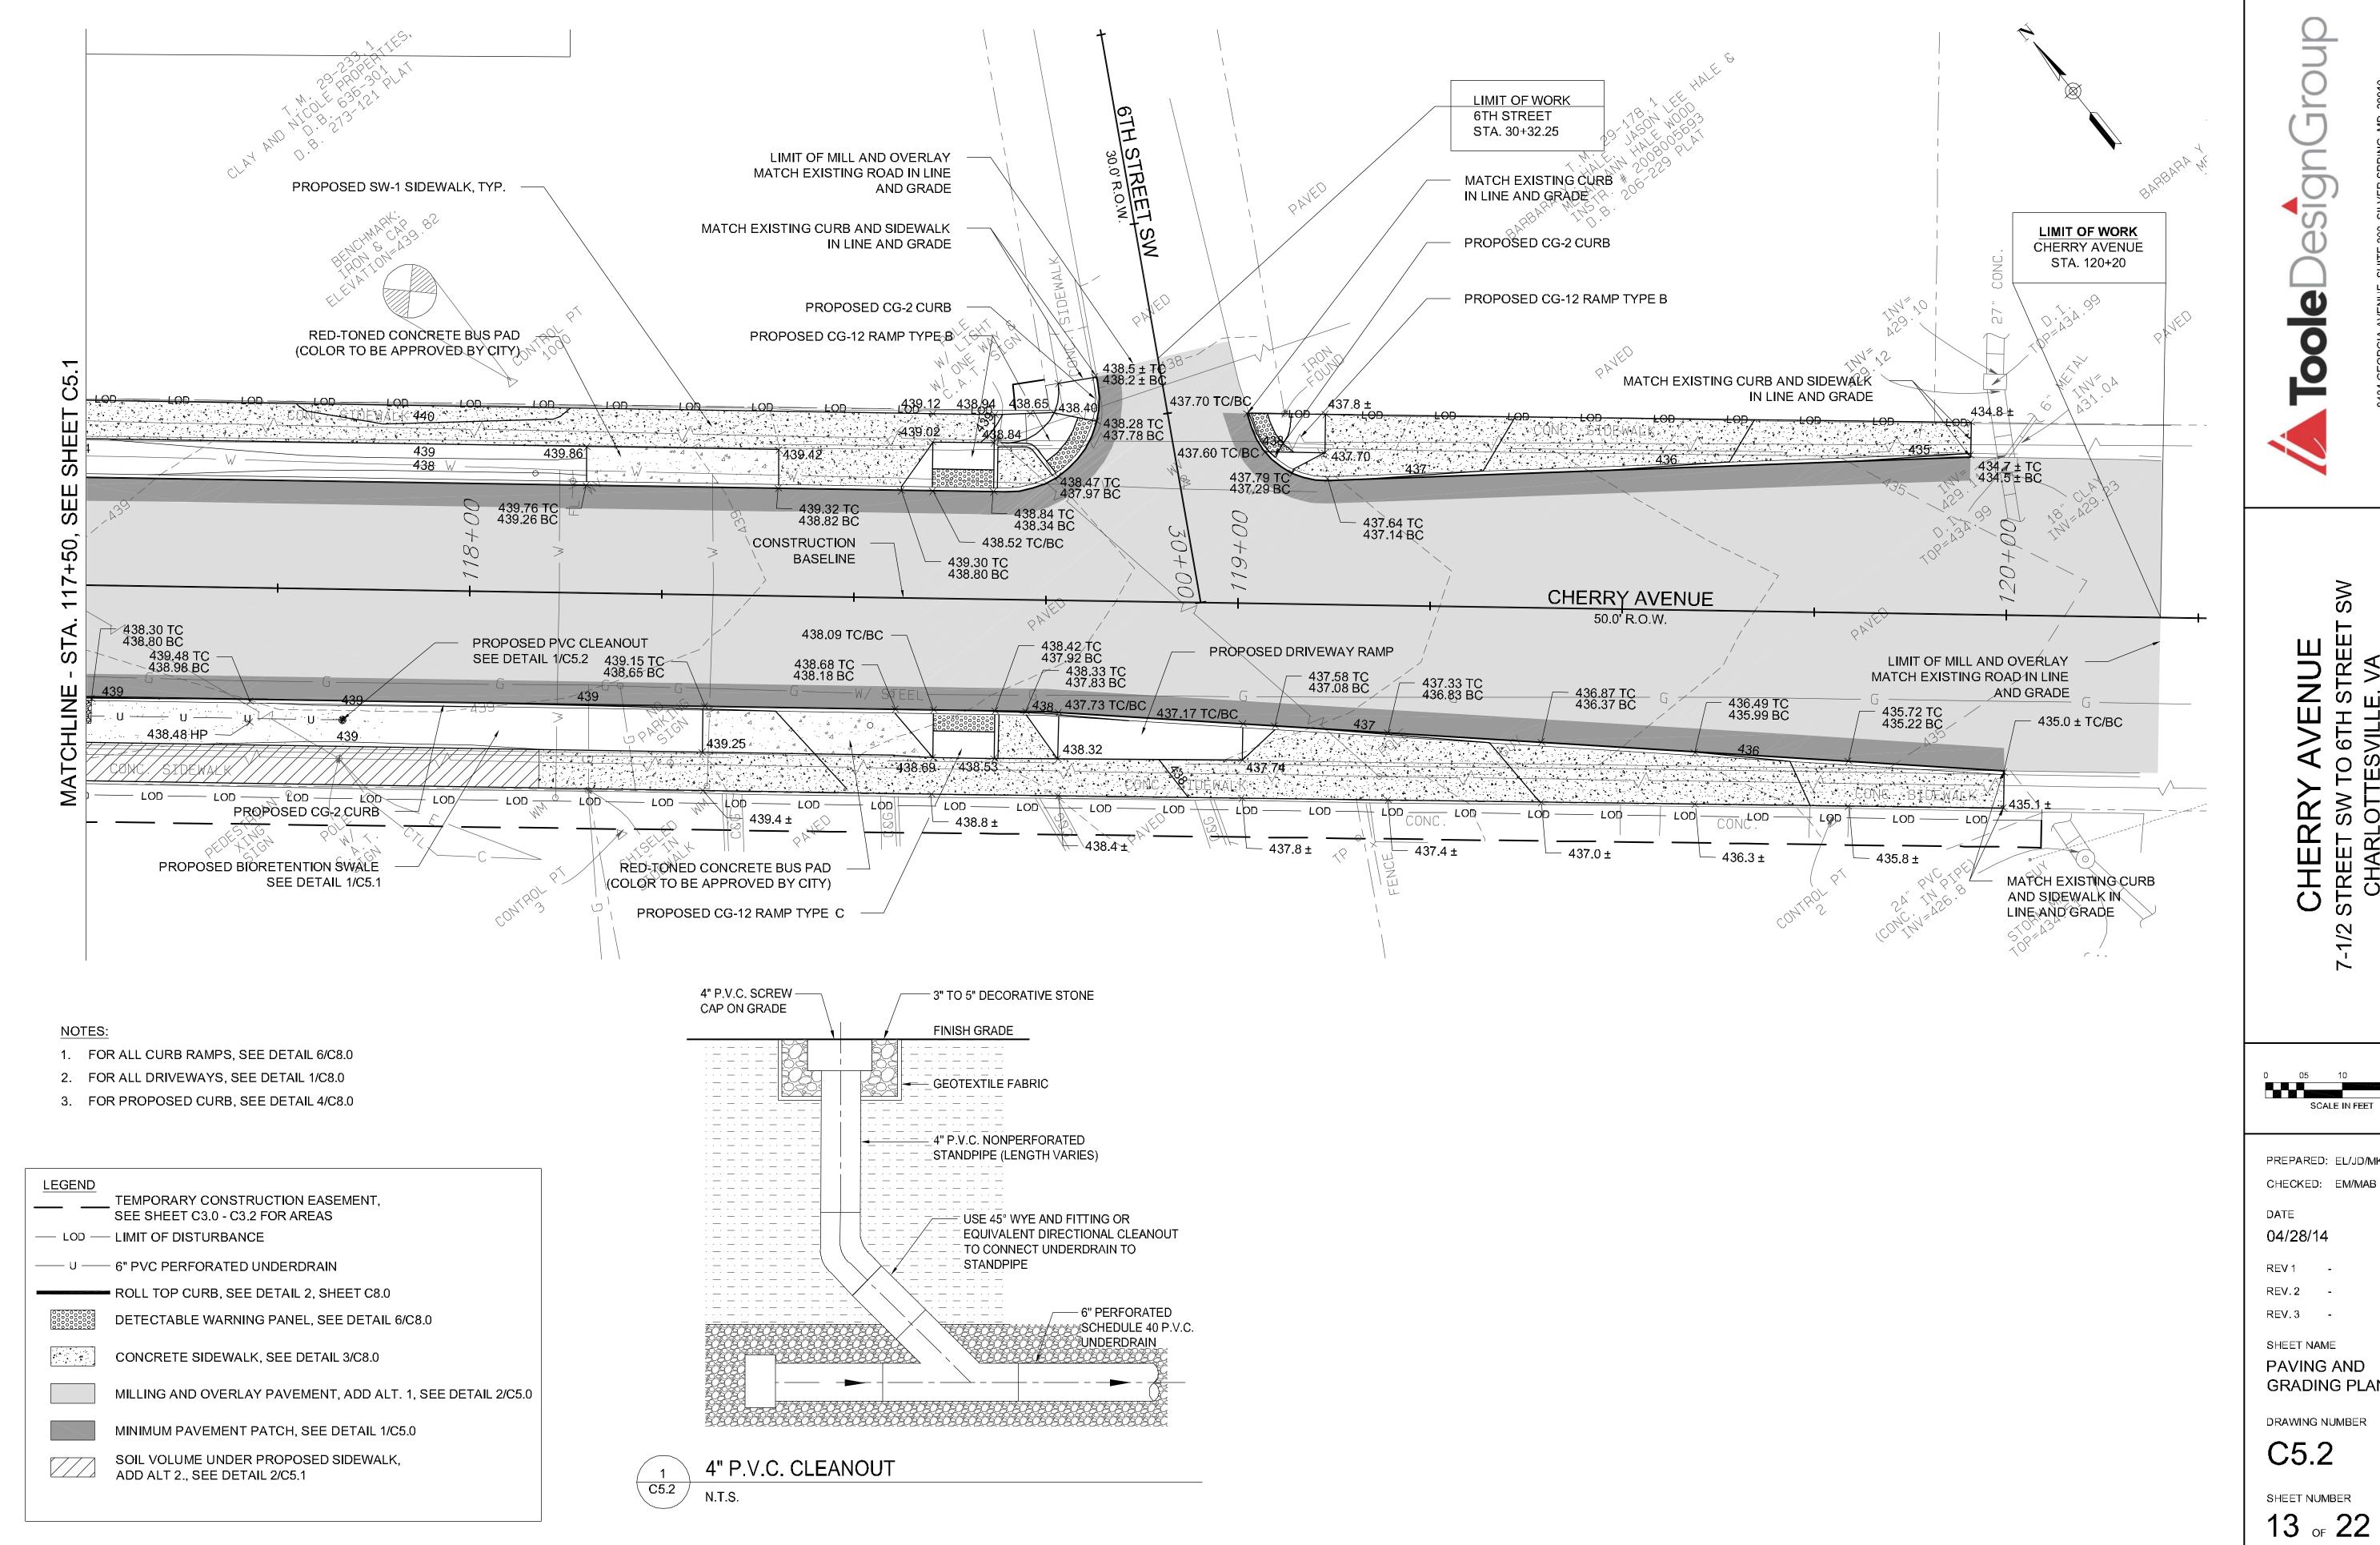

PREPARED: EL/JD/MK

PAVING AND GRADING PLAN

- 1) TYPE B CLASS I PAVEMENT MARKING WHITE SHARROW SYMBOL
- (2) TYPE B CLASS I PAVEMENT MARKING WHITE TRAFFIC ARROW (DIRECTION AS SHOWN)
- (3) TYPE B CLASS I PAVEMENT LINE MARKING 4" WHITE SOLID (EDGE LINE)
- (4) TYPE B CLASS I PAVEMENT LINE MARKING 4" WHITE 2' STRIPE, 4' SKIP (SKIP LINE)
- (5) type B class I pavement line marking 6" white solid (bike lane line or edge line)
- 6 TYPE B CLASS I PAVEMENT LINE MARKING 24" WHITE SOLID (STOP LINE OR CROSSWALK LINE)
- (7) TYPE B CLASS I PAVEMENT LINE MARKING 4" DOUBLE YELLOW STRIPE 4" SEPARATION
- (8) TYPE B CLASS I PAVEMENT LINE MARKING 4" SINGLE YELLOW 2' STRIPE, 4' SKIP (SKIP LINE)
- (9) type B class I pavement line marking 4" Double Yellow 2' stripe, 4' skip (centerline skip line)
- (10) TYPE B CLASS I PAVEMENT LINE MARKING 12" YELLOW SOLID
- DIRECTION OF TRAVEL

SIGNING AND STRIPING GENERAL NOTES

- 1. CONTRACTOR SHALL COMPLY WITH ALL APPLICABLE CITY OF CHARLOTTESVILLE AND VDOT LATEST STANDARDS AND SPECIFICATIONS. WORK SHALL ALSO MEET ALL APPLICABLE REQUIREMENTS OF THE MANUAL OF UNIFORM TRAFFIC CONTROL DEVICES (MUTCD).
- 2. THE CONTRACTOR SHALL VERIFY ALL DIMENSIONS IN THE FIELD PRIOR TO INSTALLING PROPOSED WORK. WHEN THESE PLANS ARE IN CONFLICT WITH ACTUAL SITE CONDITIONS, PROPOSED WORK MAY BE ADJUSTED AS DIRECTED BY THE ENGINEER.


 <u>SIGNING</u>
- 3. ALL SIGNS SHOWN ARE NEW UNLESS OTHERWISE NOTED.
- 4. ALL SIGNS SHALL BE HIGH INTENSITY SHEETING MEETING THE REQUIREMENTS OF AASHTO M268.
- 5. PROPOSED SIGNS SHALL BE MOUNTED SO THAT NO PORTION OF THE SIGN PANEL OVERHANGS ADJACENT ROADWAY PAVEMENT, I.E. SHALL NOT HANG IN FRONT OF A FACE OF CURB.
- 6. LATERAL CLEARANCE BETWEEN PROPOSED SIGN POSTS AND EDGE OF ADJACENT ROADWAY SHALL BE IN ACCORDANCE WITH CITY OF CHARLOTTESVILLE AND VDOT LATEST STANDARDS AND SPECIFICATIONS. IF LOCATED IN OR ADJACENT TO SIDEWALKS, A 32" MINIMUM CLEAR AND 48" PREFERRED PASSING SPACE ON EXISTING AND PROPOSED SIDEWALKS SHALL BE MAINTAINED.
- 7. ALL SIGNS SHALL HAVE A MINIMUM VERTICAL CLEARANCE OF 7 FEET FROM THE GROUND TO THE BOTTOM OF THE SIGN. IF AT ANY POINT THE CONTRACTOR CANNOT MEET THE VERTICAL CLEARANCE REQUIRED, THE CONTRACTOR SHALL CEASE WORK AND CONTACT THE ENGINEER FOR FURTHER INSTRUCTIONS.
- 8. PROPOSED SIGNS AT NEW LOCATIONS SHALL BE INSTALLED SO THEY DO NOT BLOCK THE VISIBILITY OF ANY EXISTING SIGNS OR SIGNALS.
- 9. PROPOSED SIGNS AND POSTS SHALL BE CLEAR OF EXISTING FIRE HYDRANTS, SURFACE UTILITY, AND OVERHEAD UTILITY EQUIPMENT A MINIMUM OF 10 FEET.
- 10. FOR NEW POST INSTALLATION, THE CONTRACTOR SHALL VERIFY THAT THERE ARE NO CONFLICTING UNDERGROUND OR OVERHEAD UTILITIES.
- 11. SQUARE STEEL SIGN POST INSTALLATION, SIGN PANEL MOUNTING AND HARDWARE SHALL BE IN ACCORDANCE WITH CITY OF CHARLOTTESVILLE AND VDOT STANDARDS AND SPECIFICATIONS. SIGNS SHALL BE MOUNTED ON PROPOSED SQUARE STEEL METAL POSTS UNLESS OTHERWISE NOTED IN THE PLANS.
- 12. THE CONTRACTOR SHALL SUBMIT PROOFS/ SHOP DRAWINGS OF THE PROPOSED SIGN CONTENT TO THE ENGINEER FOR APPROVAL PRIOR TO FABRICATION AND INSTALLATION.
- 13. SIGNS MOUNTED TO EXISTING LIGHT, SIGNAL OR UTILITY POLES SHALL BE FASTENED WITH A MANUFACTURED STEEL BANDING SYSTEM. POLES SHALL NOT BE DRILLED DIRECTLY. THE CONTRACTOR SHALL SUBMIT MANUFACTURER INFORMATION ON THE BANDING SYSTEM TO THE ENGINEER FOR APPROVAL PRIOR TO INSTALLATION.
- 14. EXISTING SIGNS (PANELS, HARDWARE AND/OR POSTS) THAT ARE CALLED FOR TO BE REMOVED AND NOT REUSED SHALL BE DISPOSED OF.
- 15. ALL SIGN LOCATIONS SHOWN ON THE PLANS ARE APPROXIMATE. THE CONTRACTOR SHALL VERIFY EACH LOCATION PRIOR TO INSTALLING A SIGN. IF AT ANY POINT THE CONTRACTOR FINDS A CONFLICT, THE CONTRACTOR SHALL CONTACT THE ENGINEER PRIOR TO INSTALLING THE PROPOSED SIGN.
- 16. THE CONTRACTOR SHALL VERIFY ALL DIMENSIONS IN THE FIELD PRIOR TO INSTALLING SIGNING. ADDITIONAL ADJUSTMENTS OF EXISTING SIGNS BEYOND THOSE CALLED FOR IN THESE PLANS MAY BE NECESSARY. ADDITIONAL ADJUSTMENTS WILL BE MADE AS DIRECTED BY THE ENGINEER.

 <u>STRIPING</u>
- 17. ALL PAVEMENT MARKINGS ARE TYPE B, CLASS I UNLESS OTHERWISE NOTED.
- 18. ALL STRIPING DIMENSIONS ADJACENT TO CURB ARE MEASURED TO THE FACE OF CURB.
- 19. TEXT, ARROW AND BICYCLE FACILITY SYMBOLS SHALL BE WHITE. LONGITUDINAL LOCATIONS ARE APPROXIMATE UNLESS DIMENSIONS ARE GIVEN.
- 20. ERADICATE ALL EXISTING PAVEMENT MARKINGS WITHIN THE PROJECT LIMITS UNLESS OTHERWISE NOTED. COSTS ARE INCIDENTAL TO THE ERADICATION PAY
 ITEM.

PAVEMENT MARKING QUANTITIES

	1	2	3	4	5	6	7	8	9	10	11)	(2)
SHEET NUMBER	TYPE B CLASS 1 PAVEMENT LINE MARKING WHITE SHARROW SYMBOL	TYPE B CLASS 1 PAVEMENT LINE MARKING WHITE TRAFFIC ARROW (DIRECTION AS SHOWN)	TYPE B CLASS 1 PAVEMENT LINE MARKING 4" — WHITE SOLID (EDGE LINE)	TYPE B CLASS 1 PAVEMENT LINE MARKING 4" — WHITE 2' STRIPE, 4' SKIP (SKIP LINE)	TYPE B CLASS 1 PAVEMENT LINE MARKING 6" — WHITE SOLID (BIKE LANE LINE OR EDGE LINE)	TYPE B CLASS 1 PAVEMENT LINE MARKING 24" — WHITE SOLID (STOP LINE OR CROSSWALK LINE)	TYPE B CLASS 1 PAVEMENT LINE MARKING 4" — DOUBLE YELLOW STRIPE 4" SEPARATION*	TYPE B CLASS 1 PAVEMEN LINE MARKING 4" — SINGLE YELLOW 2' STRIPE 4' SKIP (SKIP LINE)	TYPE B CLASS 1 PAVEMENT LINE MARKING 4" — DOUBLE YELLOW 2' STRIPE 4' SKIP (CENTERLINE SKIP LINE)*	TYPE B CLASS 1 PAVEMENT LINE MARKING 12" — YELLOW SOLID	ERADICATED EXISTING PAVEMENT LINE MARKINGS	ERADICATED EXISTING PAVEMENT SYMBOLS
	EA	EA	LF	LF	LF	LF	LF	LF	LF	LF	LF	EA
6.2	2	3	128	0	249	211	262	0	0	0	615	3
6.3	2	0	0	0	134	147	726	36	0	65	779	1
6.4	4	1	45	18	110	134	446	0	26	0	978	3
TOTAL	8	4	173	18	493	492	1,434	36	26	65	2,372	7

* ALL PAVEMENT MARKINGS DENOTED AS "DOUBLE" HAVE BEEN TABULATED TO SHOW THE QUANTITY ALREADY DOUBLED.

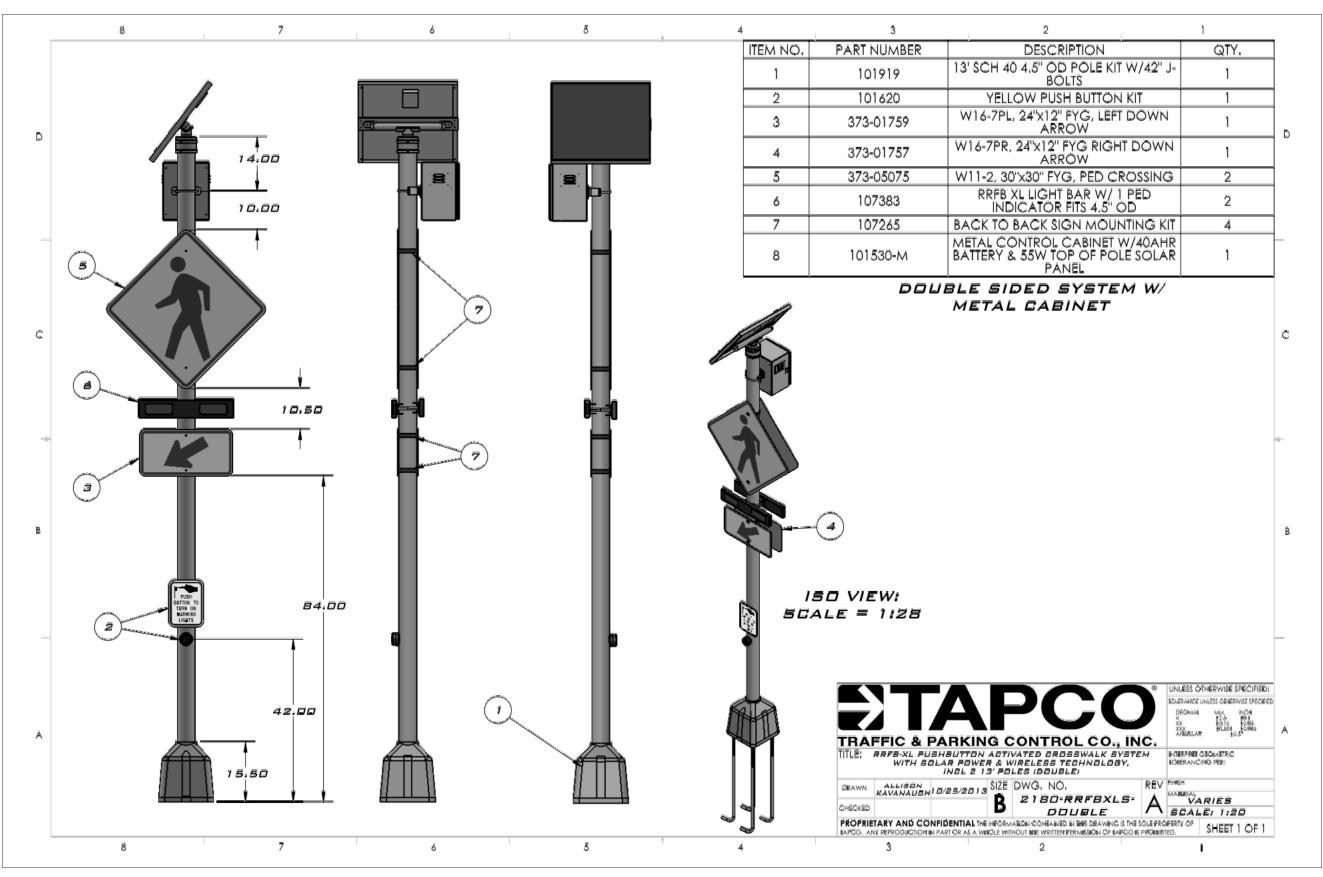

RECTANGULAR RAPID FLASH BEACON

TAPCO — TRAFFIC AND PARKING CONTROL CO. INC. OR APPROVED EQUAL

ET SW

CHERRY AVE 7-1/2 STREET SW TO 6TH CHARLOTTESVILE

0 05 10 SCALE IN FEET

PREPARED: EL/JD/MK
CHECKED: EM/MAB

04/28/14 REV1 -

REV.2 - REV.3 -

SIGNING AND MARKING PLAN

C6.0


HEET NUMBER

sheet number 14 of 22

SIGN QUANTITIES


						I	<u> </u>	I	I	Т
SHEET NO.	SIGN ASSEM. NO.	LOCATION		SIZE NCHES		TRAFFIC SIGN PANEL	METAL SIGN POST	RELOCATE EXISTING GROUND MOUNTED SIGN	REMOVE & DISPOSE EXISTING SIGN PANEL	REMARKS
	110.					SF	EA	EA	EA	
1	S-1	AT 7 1/2 STREET	36	Х	36	9.00	1			NEW W11-2 AND POST (RRFB - SEE DETAILS)
1	S-1	AT 7 1/2 STREET	24	Х	12	2.00				NEW W16-7P(R)
1	S-2	AT 7 1/2 STREET	36	Х	36	9.00	1			NEW W11-2 AND POST (RRFB - SEE DETAILS)
1	S-2	AT 7 1/2 STREET	24	Х	12	2.00				NEW W16-7P(L)
1	S-3	AT 7 1/2 STREET	36	Х	36	9.00	1			NEW W11-2 AND POST (RRFB - SEE DETAILS)
1	S-3	AT 7 1/2 STREET	24	Х	12	2.00				NEW W16-7P(L)
1	S-4	AT 7 1/2 STREET	36	Χ	36	9.00	1			NEW W11-2 AND POST (RRFB - SEE DETAILS)
1	S-4	AT 7 1/2 STREET	24	Х	12	2.00				NEW W16-7P(R)
1	S-4	AT 7 1/2 STREET	30	Х	30	6.25				NEW R4-11
2	S-5	BETWEEN 7 1/2 STREET AND 6 1/2 STREET	36	Х	36	9.00	1			NEW W11-1 AND POST
2	S-5	BETWEEN 7 1/2 STREET AND 6 1/2 STREET	24	Х	18	3.00				NEW 16-1P
2	S-6	BETWEEN 7 1/2 STREET AND 6 1/2 STREET	36	Х	36	9.00	1			NEW W11-1 AND POST
2	S-6	BETWEEN 7 1/2 STREET AND 6 1/2 STREET	24	Х	18	3.00				NEW 16-1P
2	S-7	AT 6 1/2 STREET	36	Х	36	9.00	1			NEW W11-2 AND POST
2	S-7	AT 6 1/2 STREET	24	Х	12	2.00				NEW W16-7P(R)
2	S-7	AT 6 1/2 STREET	36	Х	36	9.00	1			NEW W11-2 AND POST
2	S-7	AT 6 1/2 STREET	24	Х	12	2.00				NEW W16-7P(L)
2	S-8	AT 6 1/2 STREET	36	Х	36	9.00	1			NEW W11-2 AND POST
2	S-8	AT 6 1/2 STREET	24	Х	12	2.00				NEW W16-7P(R)
2	S-8	AT 6 1/2 STREET	36	Х	36	9.00	1			NEW W11-2 AND POST
2	S-8	AT 6 1/2 STREET	24	Х	12	2.00				NEW W16-7P(L)
2	S-9	AT 6 1/2 STREET	-	-	-	-	-	1		RELOCATE THIS ENTIRE ASSEMBLY AND POLE TO NEW LOCATION AT S-10
2	S-10		-	-	-	-	-	-	-	RELOCATED ASSEMBLY AND POLE FROM S-9
3	S-11	BETWEEN 6 1/2 STREET AND 6TH STREET	-	-	-	-	-	-	-	RELOCATED CAT BUS SIGN FROM ASSEMBLY S-16
3	S-12	BETWEEN 6 1/2 STREET AND 6TH STREET	-	-	-	-		1		RELOCATE EXISTING CAT BUS SIGN TO ASSEMBLY S-14
3	S-13	AT 6TH STREET	36	Х	36	9.00	1			NEW W11-2 AND POST
3	S-13	AT 6TH STREET	24	Х	12	2.00				NEW W16-7P(R)
3	S-13	AT 6TH STREET	36	Х	36	9.00	1			NEW W11-2 AND POST
3	S-13	AT 6TH STREET	24	Х	12	2.00				NEW W16-7P(L)
3	S-14	AT 6TH STREET	-	-	-	-	-	-	-	RELOCATED CAT BUS SIGN FROM ASSEMBLY S-12
3	S-15	AT 6TH STREET	36	Х	36	9.00	1			NEW W11-2 AND POST
3	S-15	AT 6TH STREET	24	Χ	12	2.00				NEW W16-7P(R)
3	S-15	AT 6TH STREET	36	Χ	36	9.00	1			NEW W11-2 AND POST
3	S-15	AT 6TH STREET	24	Χ	12	2.00				NEW W16-7P(L)
3	S-16	AT 6TH STREET	-	-	-	-	-	1		RELOCATE EXISTING CAT BUS SIGN TO ASSEMBLY S-11
3	S-17	AT 6TH STREET	36	Χ	36	9.00	1			NEW W11-1 AND POST
3	S-17	AT 6TH STREET	24	Χ	18	3.00				NEW 16-1P
		TOTAL NOTE: [S] = STRAIGHT ARROW [L]= LEFT				174.25	15	3	0	

NOTE: [S] = STRAIGHT ARROW, [L]= LEFT ARROW, [R] = RIGHT ARROW

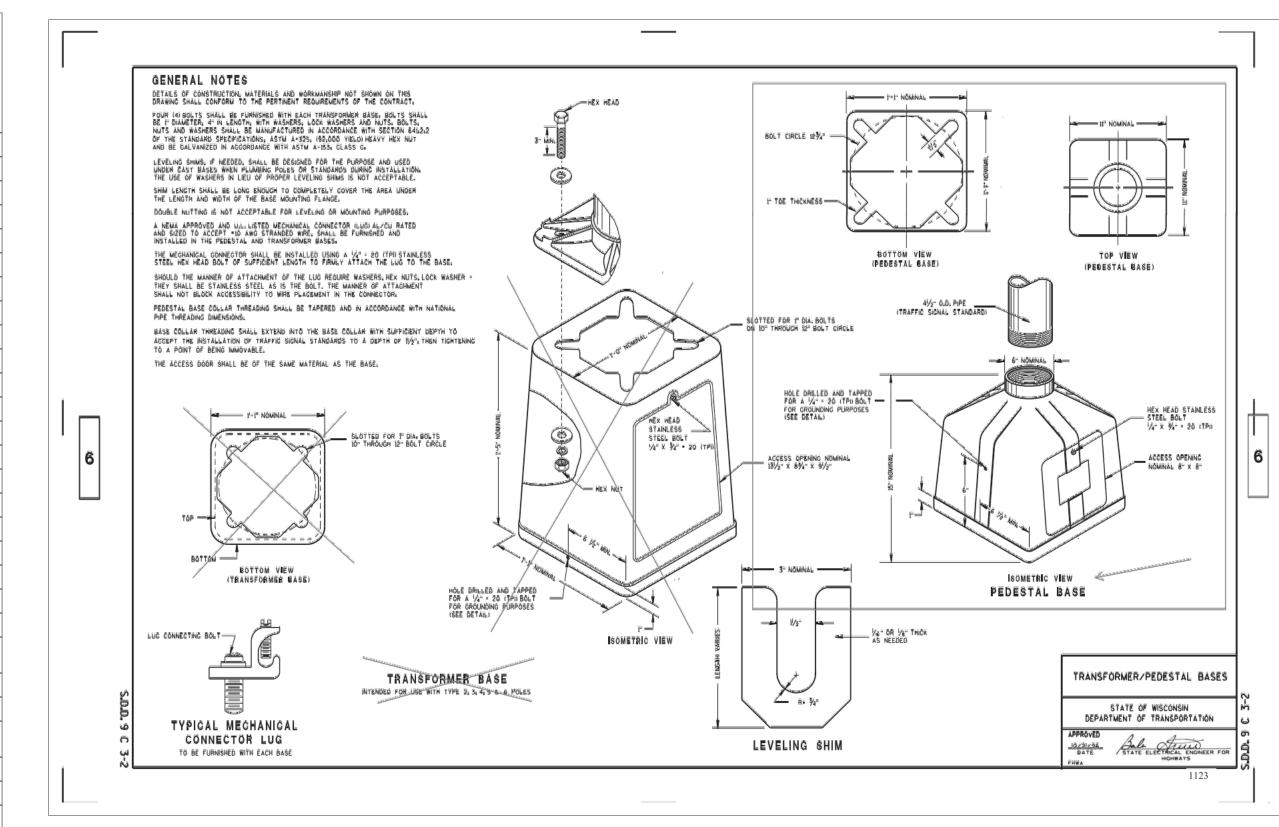

RECTANGULAR RAPID FLASH BEACON

TAPCO — TRAFFIC AND PARKING CONTROL CO. INC. OR APPROVED EQUAL

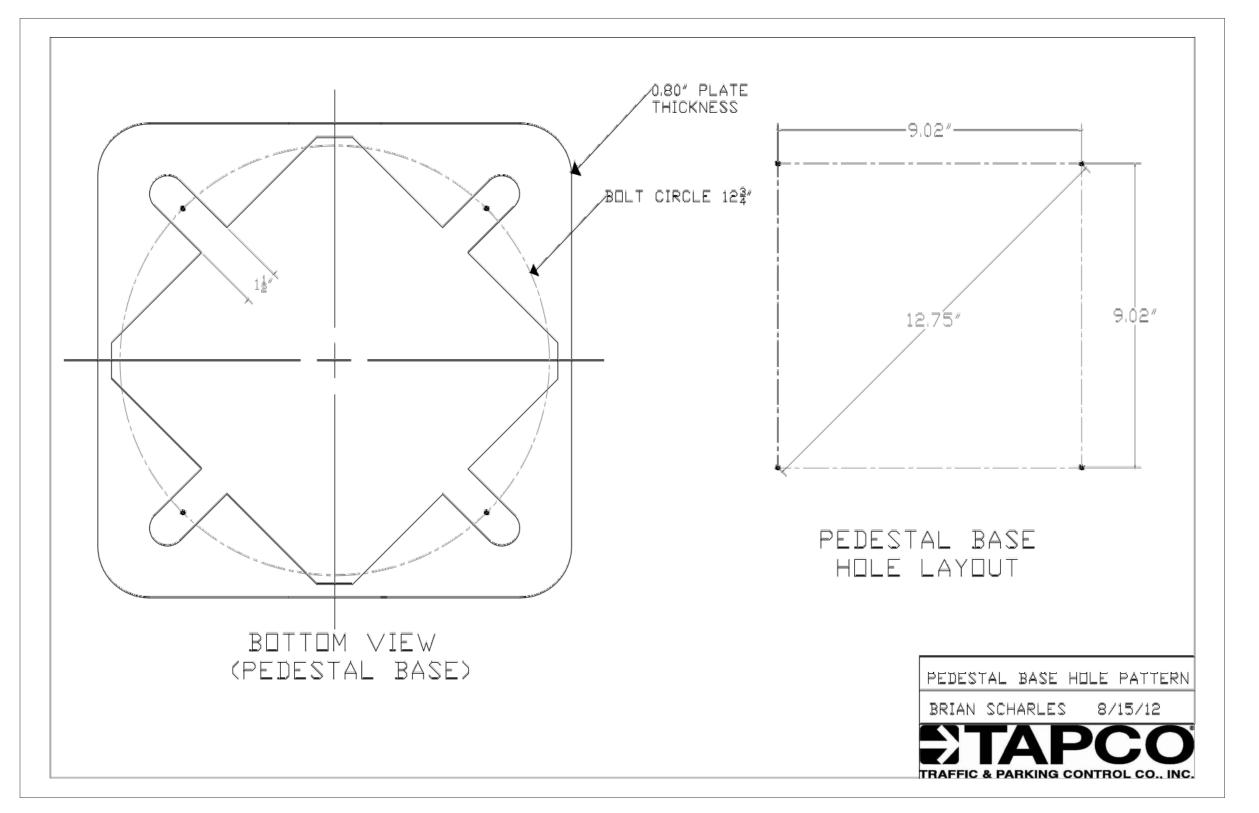

RECTANGULAR RAPID FLASH BEACON

C6.1 TAPCO - TRAFFIC AND PARKING CONTROL CO. INC. OR APPROVED EQUAL

04/28/14

REV 1 - REV. 2 -

REV.3 -

SHEET NAME
SIGNING AND
MARKING PLAN

DRAWING NUMBER

C6.1

sheet number 15 of 22

0 05 10
SCALE IN FEET

PREPARED: EL/JD/MK
CHECKED: EM/MAB

date 04/28/14

REV 1 - REV. 2 -

REV. 2 - REV. 3 -

SHEET NAME SIGNING AND MARKING PLAN

DRAWING NUMBER

C6.2

sheet number 16 of 22

SIGN LEGEND

ALL EXISTING SIGNS SHOWN ARE TO REMAIN IN PLACE UNLESS OTHERWISE NOTED.

EXISTING OR RELOCATED SIGN POST

RD

EXISTING SIGN PANEL TO REMAIN

NEW SIGN TO BE INSTALLED

RELOCATED LOCATION OF EXISTING SIGN

NEW SIGN TO BE INSTALLED

NOTE: ALL EXISTING PAVEMENT MARKINGS WITHIN

PROJECT LIMITS ARE TO BE ERADICATED UNLESS OTHERWISE

NOTED.

SIGN LEGEND

ALL EXISTING SIGNS SHOWN ARE TO REMAIN IN PLACE UNLESS OTHERWISE NOTED.

EXISTING OR RELOCATED SIGN POST

EXISTING SIGN PANEL TO REMAIN

// NEW SIGN TO BE INSTALLED

RELOCATED LOCATION OF EXISTING SIGN

• NEW SIGN TO BE INSTALLED

PROPOSED SIGNAL POLE AND MAST ARM

PROPOSED PEDESTRIAN POLE

NOTE: ALL EXISTING PAVEMENT MARKINGS WITHIN

PROJECT LIMITS ARE TO BE ERADICATED UNLESS OTHERWISE

NOTED.

CHERRY AVENUE -1/2 STREET SW TO 6TH STREET SW

0 05 10

SCALE IN FEET

PREPARED: EL/JD/MK
CHECKED: EM/MAB

04/28/14


REV.2 - REV.3 -

SHEET NAME
SIGNING AND
MARKING PLAN

DRAWING NUMBER

C6.3

sheet number 17 of 22

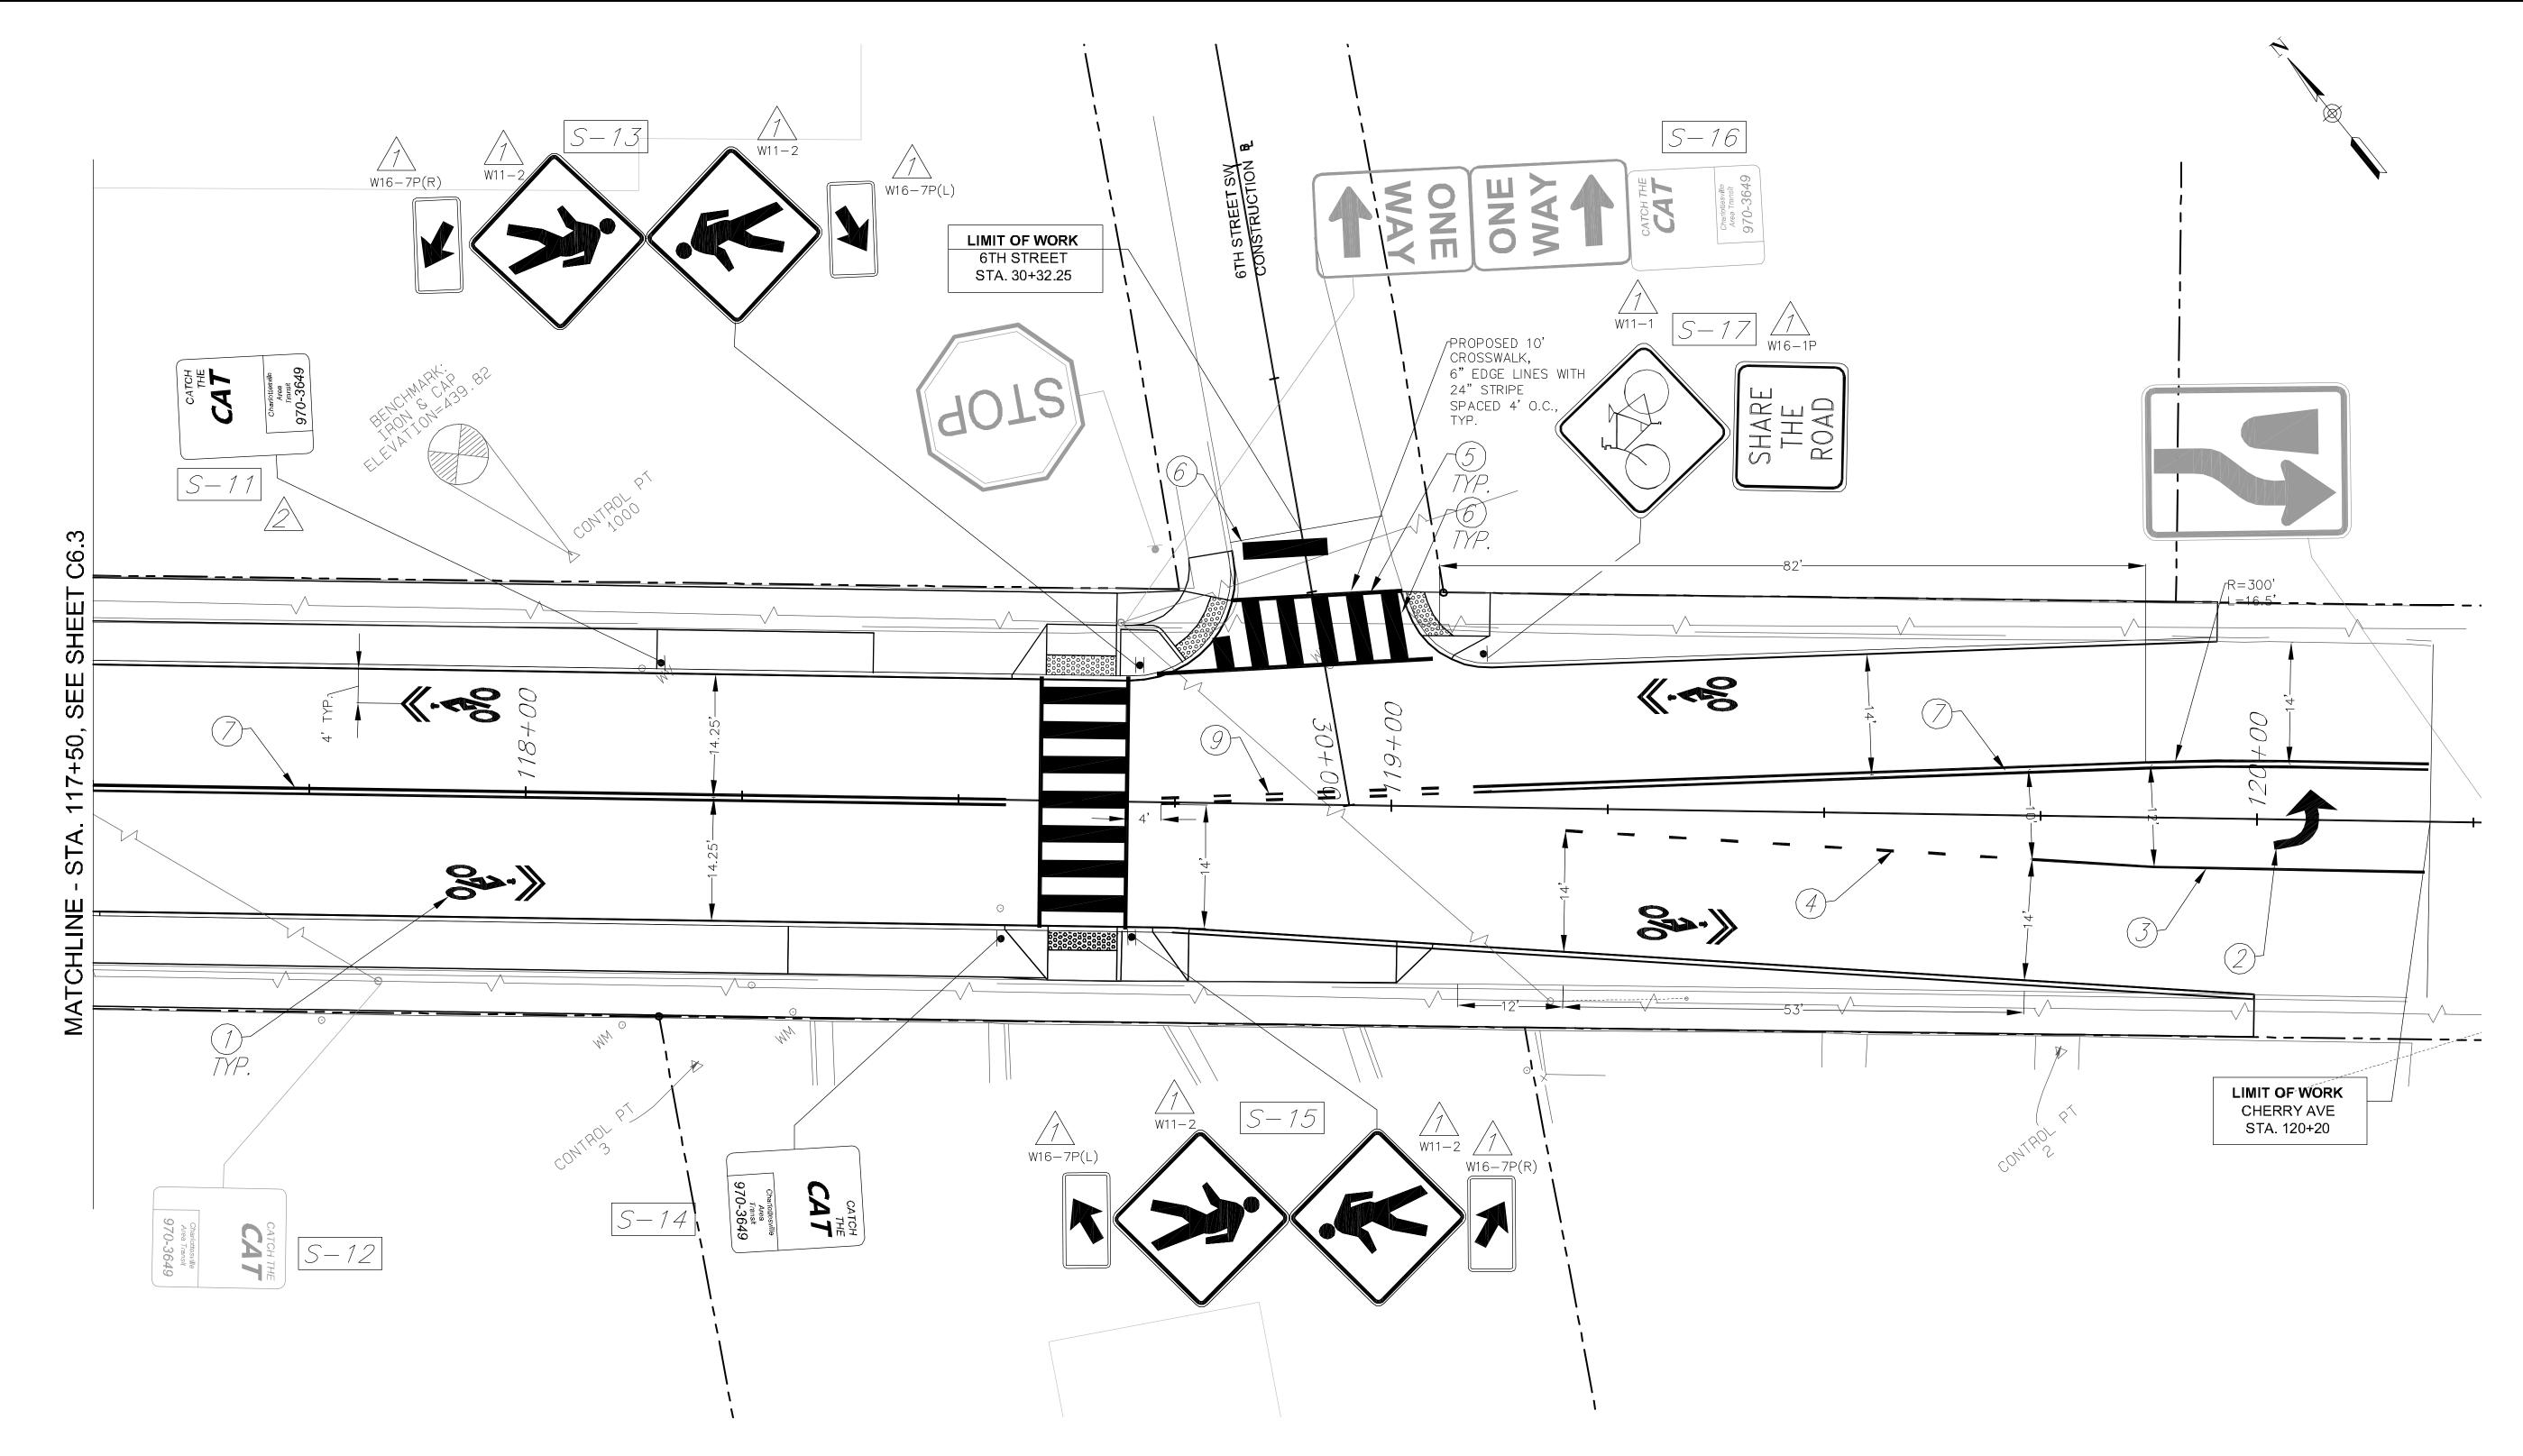

SIGN LEGEND

ALL EXISTING SIGNS SHOWN ARE TO REMAIN IN PLACE UNLESS OTHERWISE NOTED.

EXISTING OR RELOCATED SIGN POST

EXISTING SIGN PANEL TO REMAIN

NEW SIGN TO BE INSTALLED

RELOCATED LOCATION OF EXISTING SIGN

NEW SIGN TO BE INSTALLED

PROPOSED SIGNAL POLE AND MAST ARM

PROPOSED PEDESTRIAN POLE

NOTE: ALL EXISTING PAVEMENT MARKINGS WITHIN

PROJECT LIMITS ARE TO BE ERADICATED UNLESS OTHERWISE

NOTED.

CHERRY AVENUE
7-1/2 STREET SW TO 6TH STREET SW

esign(

Toole

0 05 10

PREPARED: EL/JD/MK
CHECKED: EM/MAB

04/28/14

REV 1 - REV . 2 -

REV.3 -

SHEET NAME
SIGNING AND
MARKING PLAN

DRAWING NUMBER

C6.4

18 of **22**


REV 2 REV.3 -


SHEET NAME LANDSCAPE PLANS

DRAWING NUMBER

C7.0

SHEET NUMBER 19 of 22

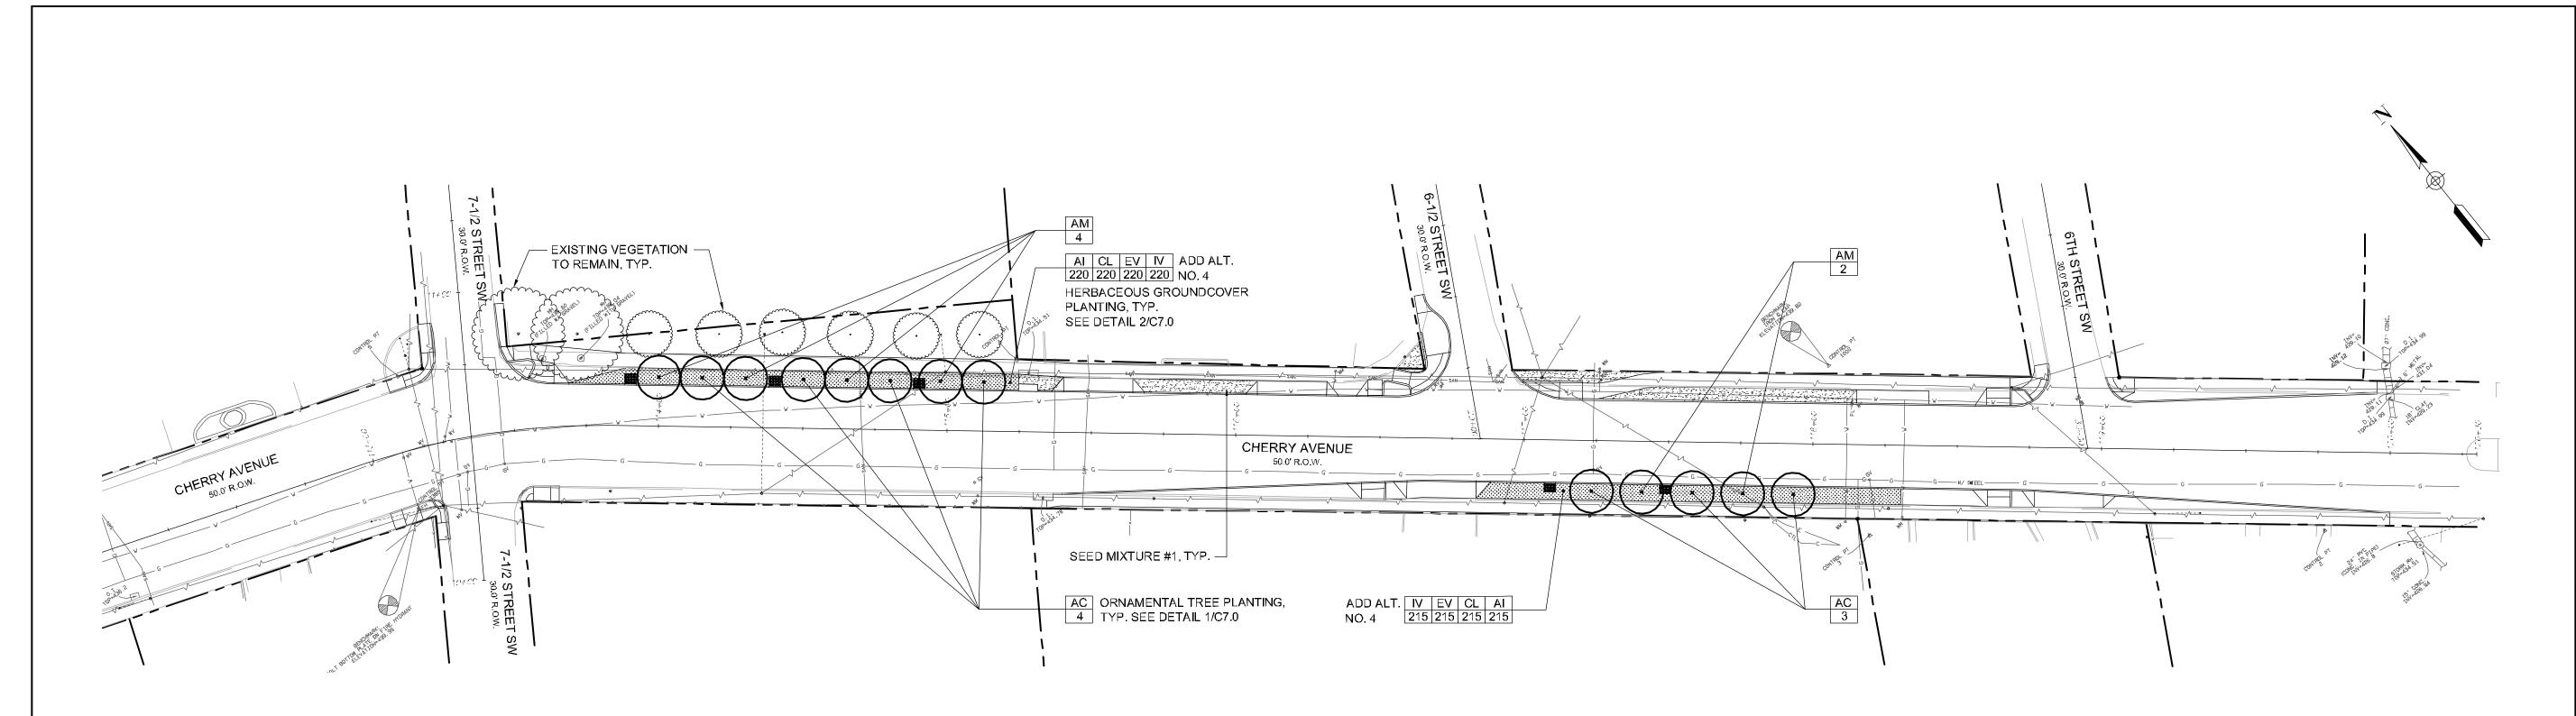

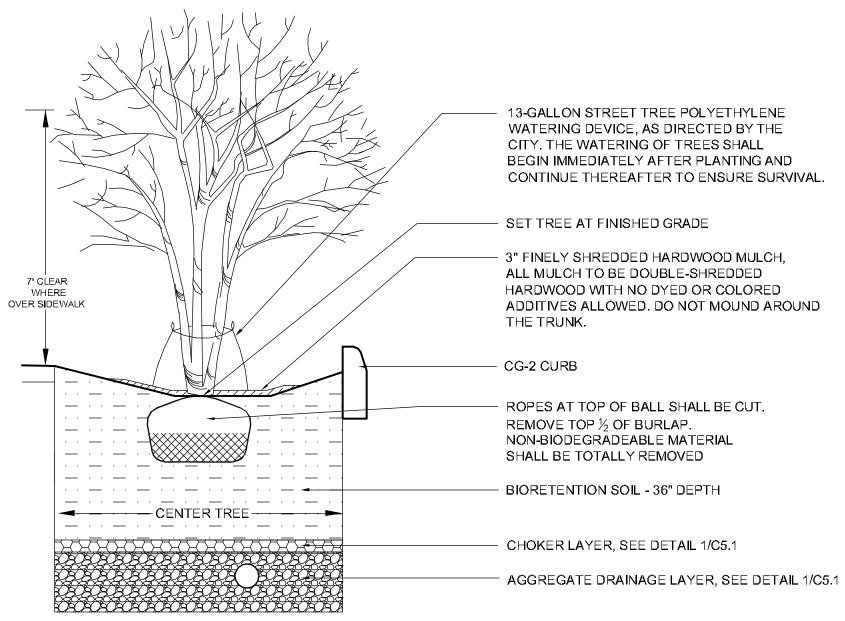

NOTES:

- REMOVE ALL PAVEMENT, GRAVEL, SUB-BASE AND CONSTRUCTION DEBRIS BEFORE
- PREPARING SOIL AND PLANTING TREES. 2. ALL PLASTIC TIES, LABELS, ETC., ARE TO BE REMOVED FROM THE BRANCHES OR TRUNK
- TO PREVENT GIRDLING.
- 3. REMOVE COMPACTED SOIL AND ADD 36" NEW BIORETENTION SOIL.
- 4. AT PLANTING PRUNE ONLY CROSSING LIMBS, CO-DOMINANT LEADERS, BROKEN OR DEAD BRANCHES, AND ANY BRANCHES THAT POSE A HAZARD TO PEDESTRIANS.

ORNAMENTAL TREE PLANTING

C7.0 NTS

PLANT SCHEDULE

Symbol	Qty	Botanical Name	Common Name	Size/Type	Spacing	Remarks
ORNAME	ENTAL T	REES				
AM	6	Acer campestre 'Metro Gold'	Metro Gold Hedge Maple	6'-8' Ht. / B&B	As Shown	Branch up to 7' ht. where over sidewalk
AC	7	Amelanchier canadensis	Shadblow Serviceberry	6'-8' Ht. / B&B	As Shown	Branch up to 7' ht. where over sidewalk
HERBAC	CEOUS G	GROUNDCOVER - ADD ALT NO. 4	ļ.			
HERBAC	CEOUS G	GROUNDCOVER - ADD ALT NO. 4	ı			
HERBAC Al	CEOUS G	GROUNDCOVER - ADD ALT NO. 4 Asclepias incarnata	Swamp Milkweed (w)	Plug	12" O.C.	Install in clumps of 5-9 plants, alternate with clumps of EV in the center of the planting strip
				Plug Plug	12" O.C. 12" O.C.	Install in clumps of 5-9 plants, alternate with clumps of EV in the center of the planting strip Install in clumps of 5-9 plants, alternate with clumps of IV along the outsides of the planting strip
AI	435	Asclepias incarnata	Swamp Milkweed (w)	-		

LEGEND:

Small Ornamental Tree,

Seed Mixture #1 - Outsidepride.com's "Combat

Outsidepride.com's "Garland Grass Seed Mix", or approved equal, should alternative not be

Extreme™ Southern Zone" or approved equal

Herbaceous Plantings - Add Alt. No. 4. OR

Area to be seeded with Seed Mixture #2 -

See Detail 1/C7.0

Plant Reference


applicable.

- 3" to 5" in DIA

Decorative River Stone


NOLES:


- 1. FINAL PLANT SPECIES SELECTION TO BE APPROVED BY THE CITY PRIOR TO INSTALLATION.
- WET-TOLERANT (w) SPECIES SHALL BE PLANTED NEAR THE CENTER OF THE SWALE AND DRY-TOLERANT (d) SPECIES AT THE EDGES.
- 3. TREE SPECIES SELECTED FOR THEIR SIZE, SALT TOLERANCE, AND ABILITY TO WITHSTAND DRY AND WET CONDITIONS
- 4. HERBACEOUS GROUNDCOVER AREA TO BE SEEDED WITH OUTSIDEPRIDE.COM'S "GARLAND GRASS SEED MIX", OR APPROVED EQUAL, SHOULD ALTERNATIVE NOT BE APPLICABLE.

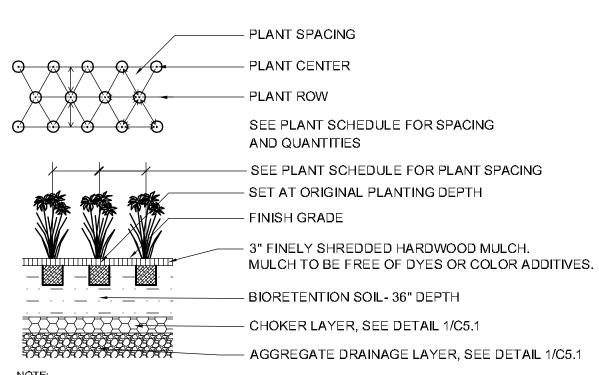



NOTE: 1. PLANT QUANTITIES DETERMINED BY MULTIPLYING AREA (SQ. FT.) BY NUMBER OF PLANTS/SQ. FT. FOR REQUIRED SPACING.


HERBACEOUS GROUNDCOVER PLANTING - ADD ALT. NO. 4 C7.0 NTS

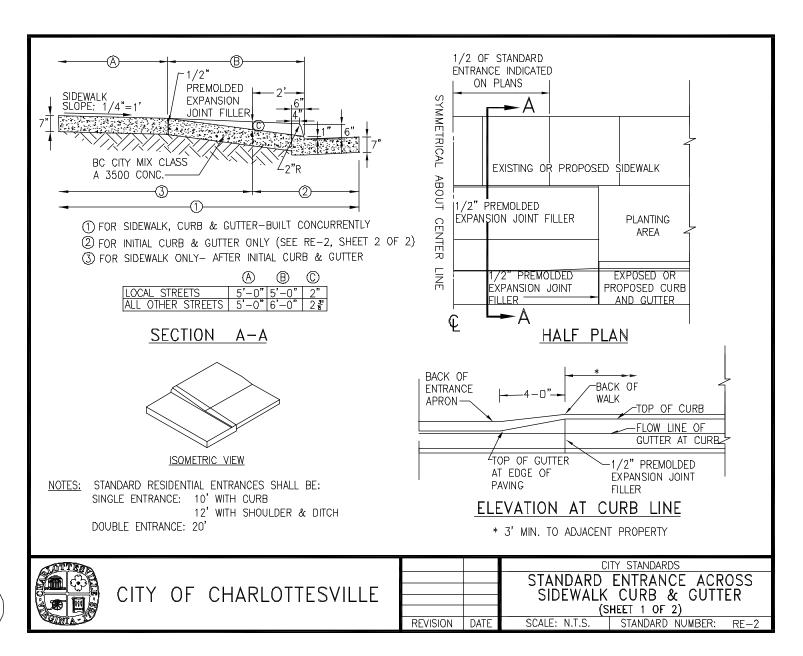


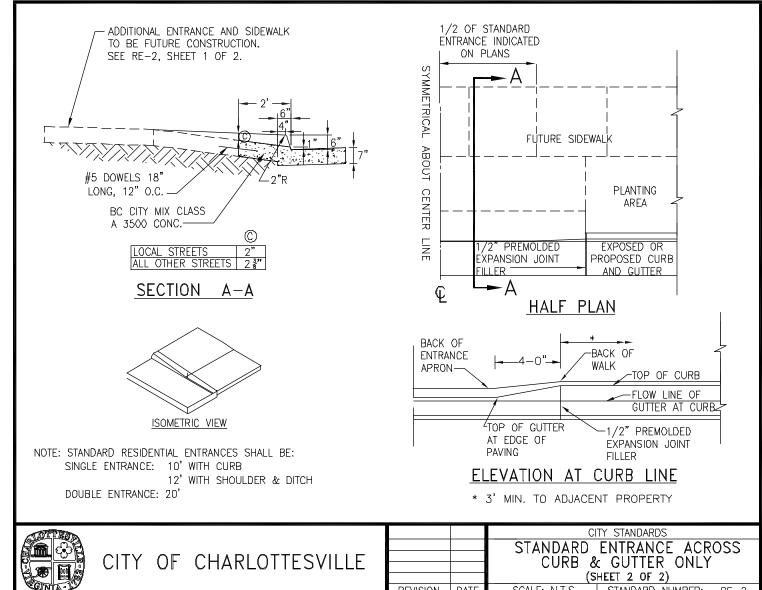


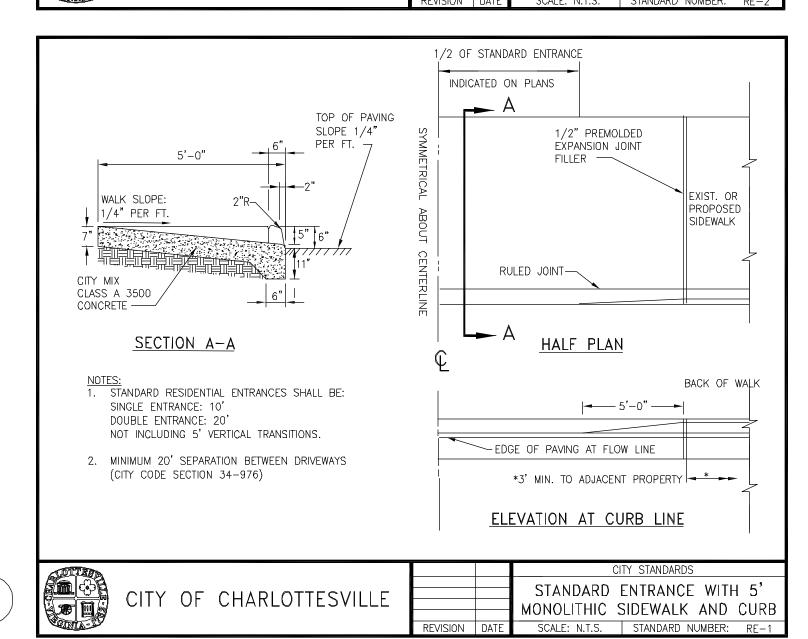


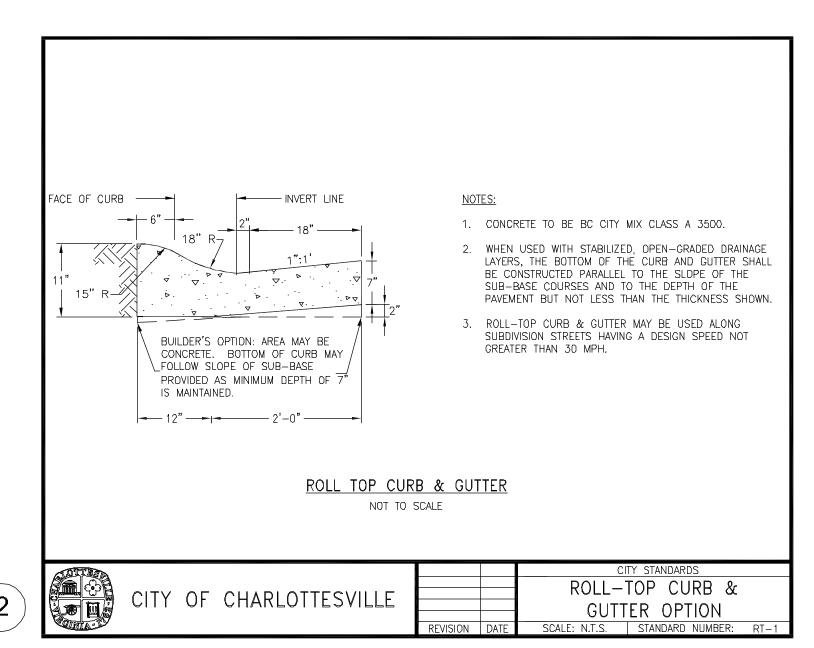

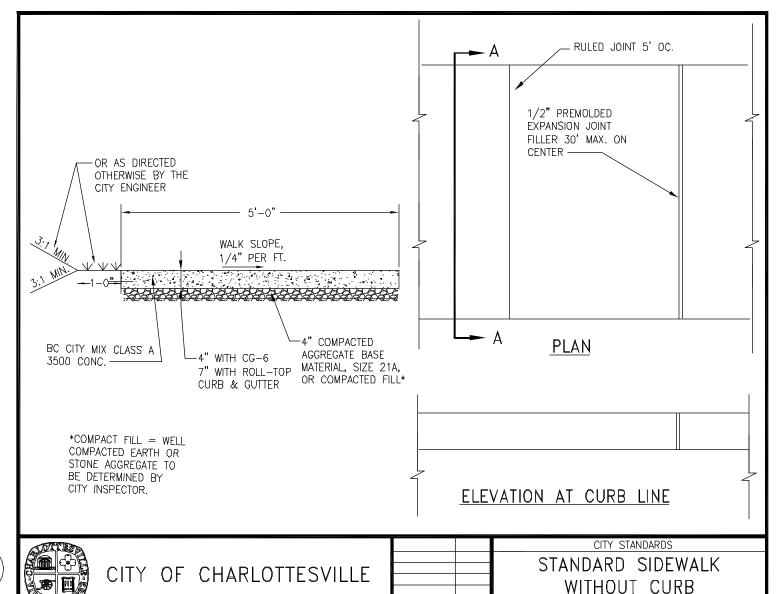

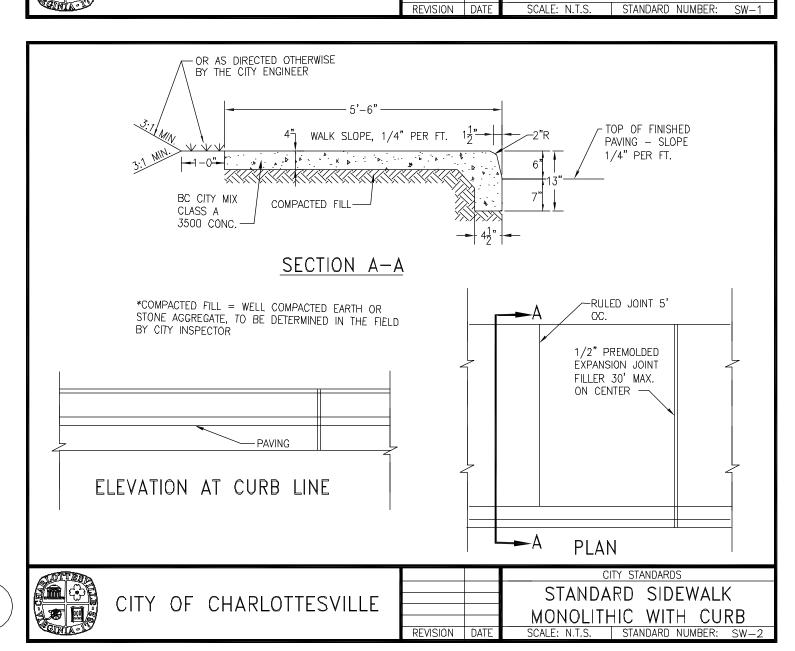

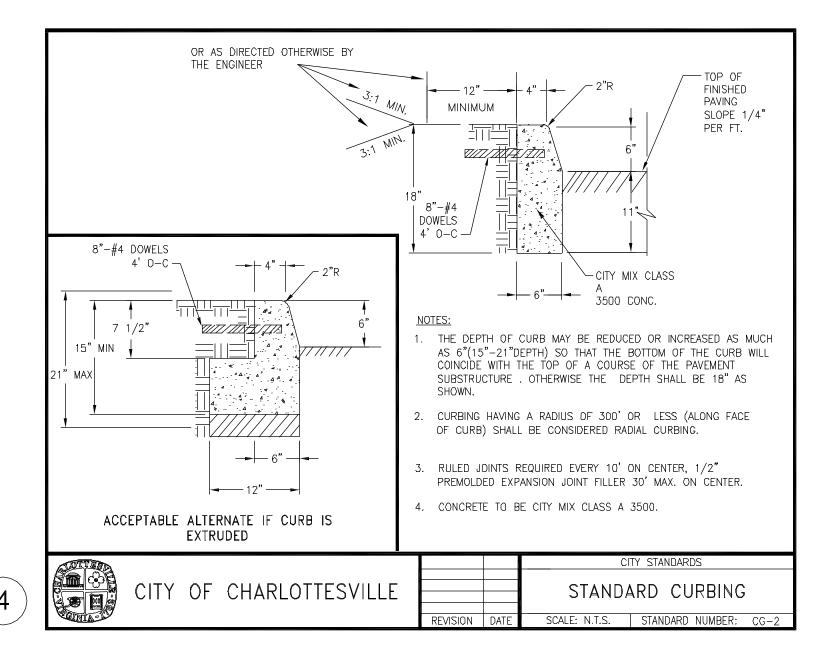

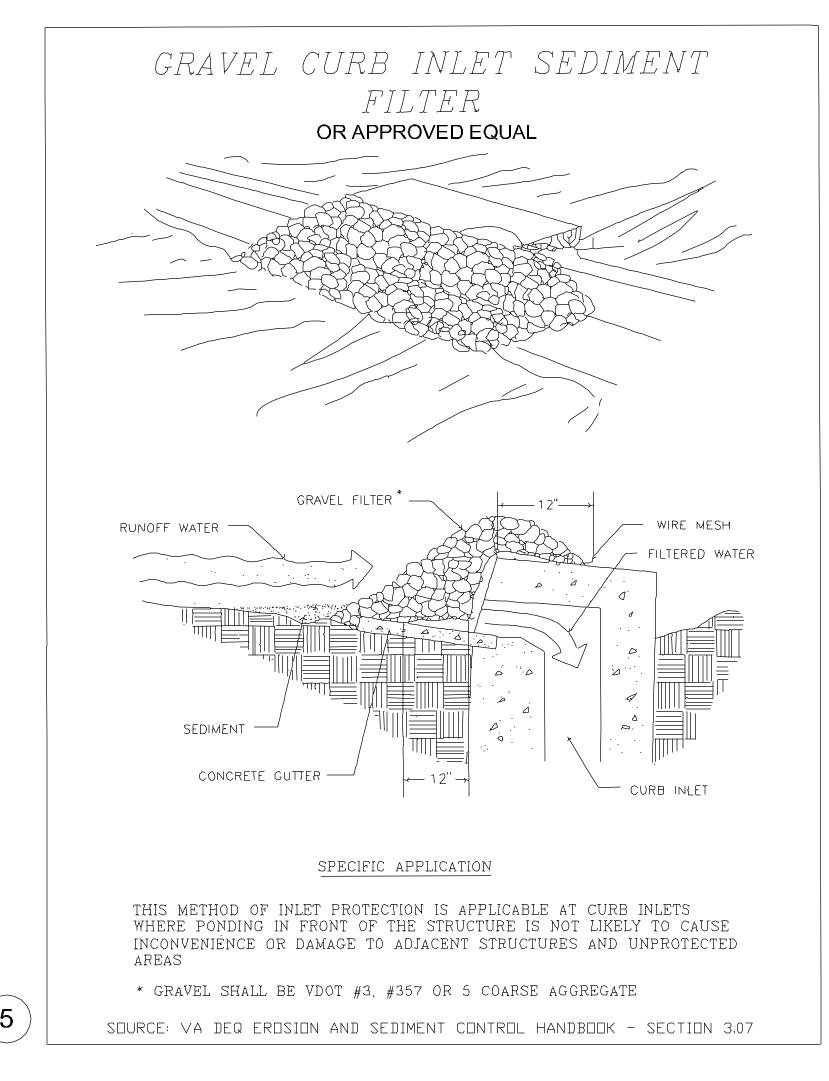



CHERRY AVENUE
STREET SW TO 6TH STREET SW

PREPARED: EL/JD/MK
CHECKED: EM/MAB

DATE 04/28/14

REV 1 - REV. 2 -


REV.3 -SHEET NAME


STANDARD DETAILS


DRAWING NUMBER

C8.0

sheet number 20 of 22

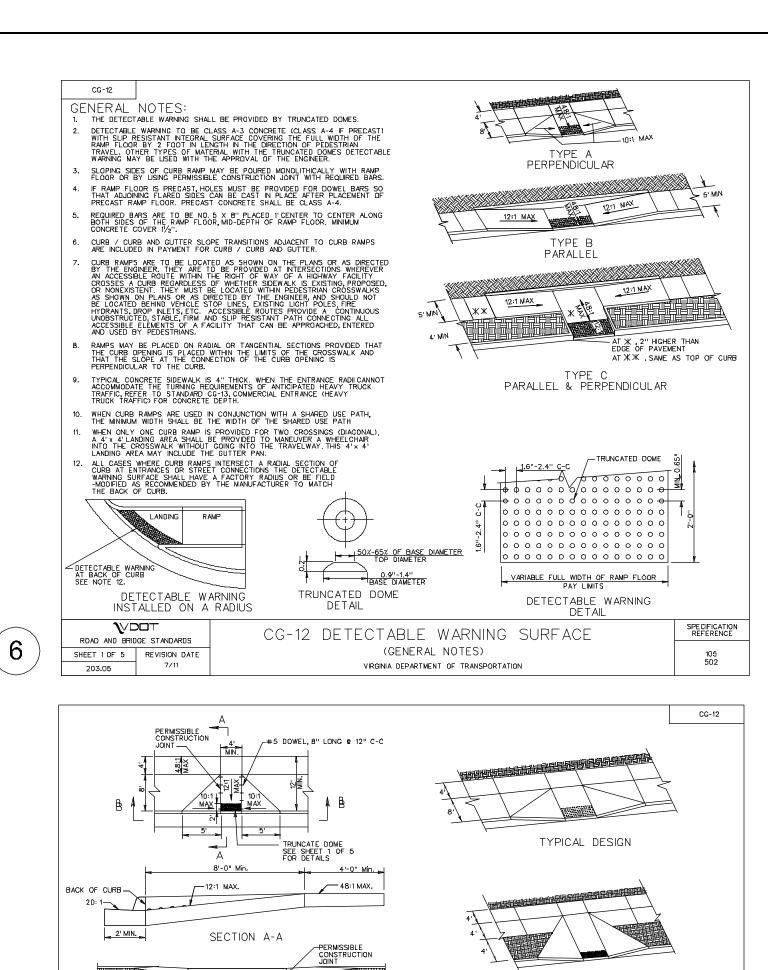

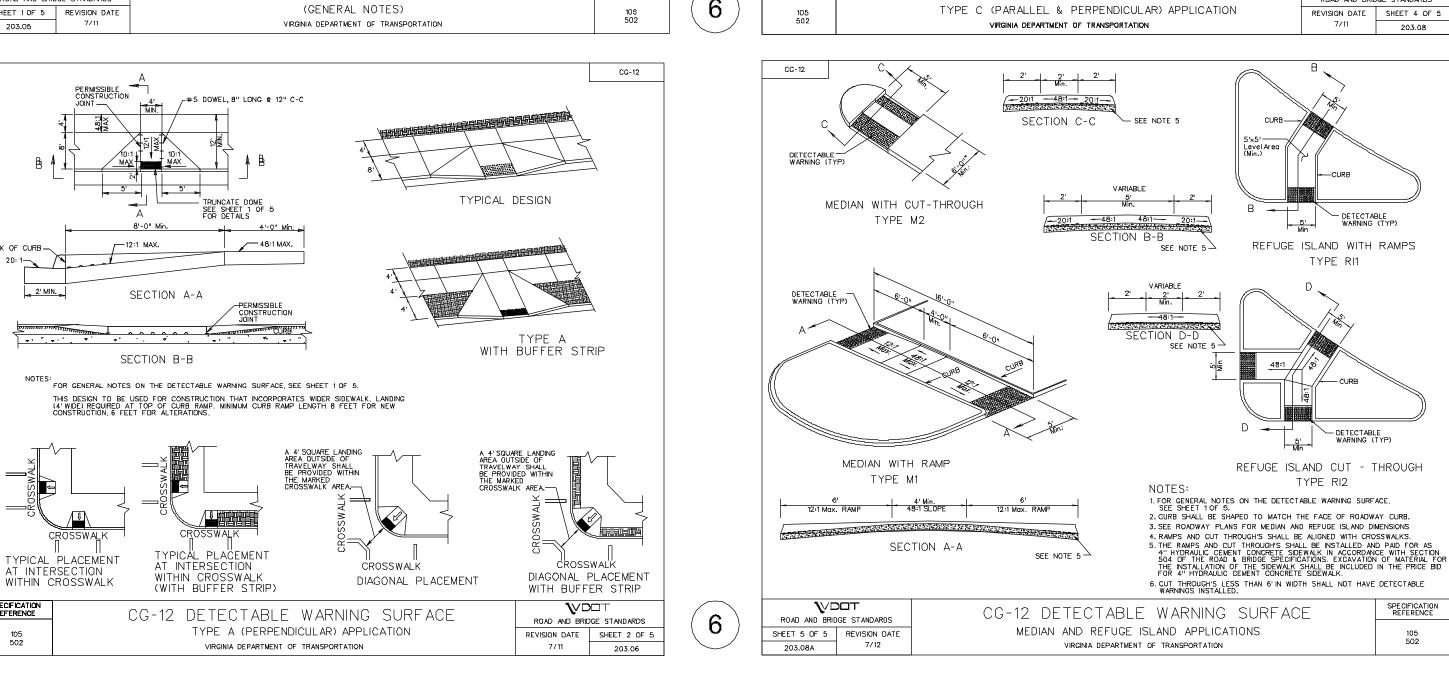

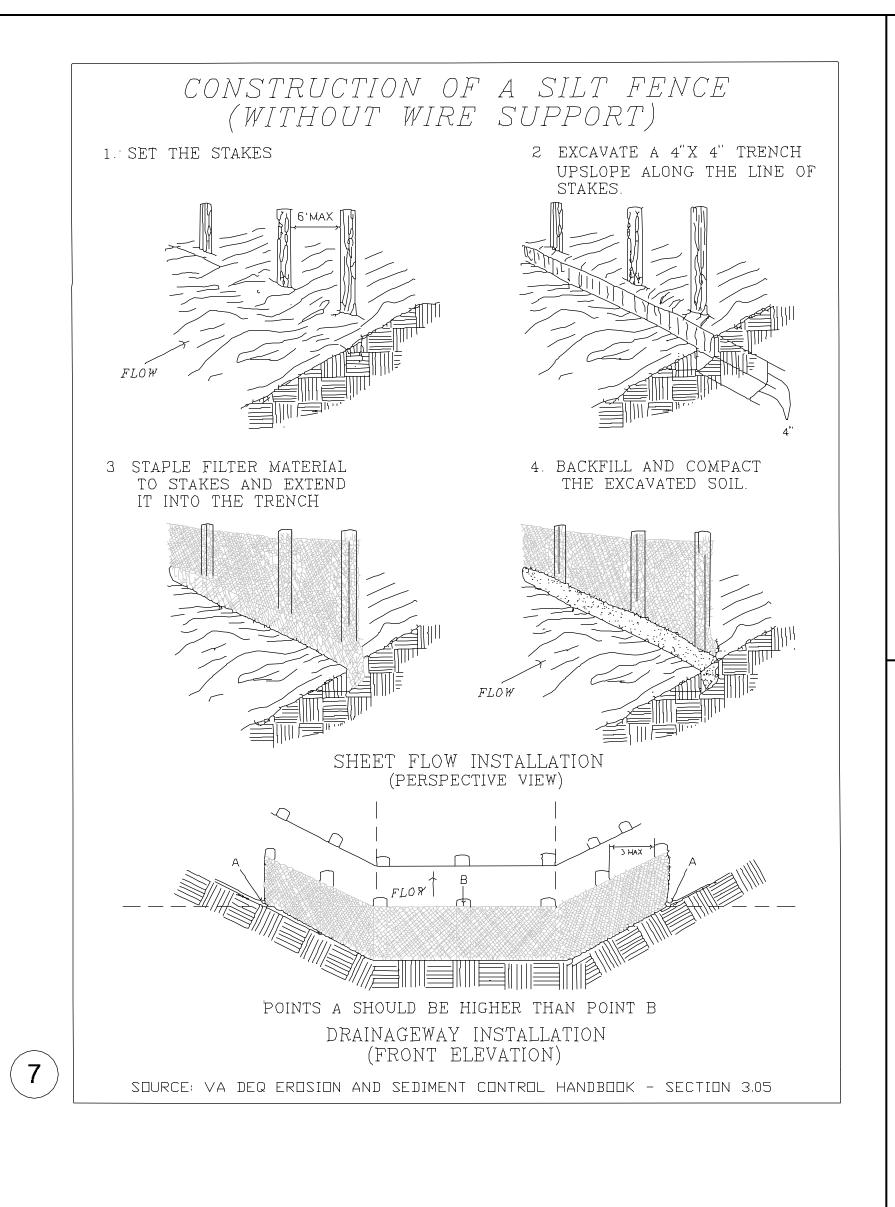

CG-12

CROSSWALK

TYPICAL PLACEMENT AT INTERSECTION WITH BUFFER STRIP

AT Ж , 2" HICHER THAN EDGE OF PAVEMENT ATЖЖ,SAME AS TOP OF CURB

5'SIDE WALK

4' BUFFER STRIP

NOTES: FOR GENERAL NOTES ON THE DETECTABLE WARNING SURFACE, SEE SHEET 1 OF 5.

THE SELECTION OF CURB TYPE AND THE CONFIGURATION OF THE BUFFER STRIP MAY VARY TO MEET EXISTING FIELD CONDITIONS AND ROADWAY GEOMETRICS PROVIDING THE DIMENSIONS AND SLOPES ARE AS NOTED.

THIS COMBINED (PARALLEL & PERPENDICULAR) DESIGN CAN BE USED WITH ADJOINING BUFFER STRIP. LANDING AT BOTTOM OF TWO SLOPING SIDES WITH 5' X 5' MIN. DIMENSIONS. THE SHORT PERPENDICULAR RUN TO THE STREET CAN BE PROTECTED BY A LANDSCAPED SETBACK OR CONNECTED TO THE SIDEWALK WITH A WARPED SURFACE.

TRAVELWAY SHALL
BE PROVIDED WITHIN
THE MARKED
CROSSWALK AREA.

AT X .2" HIGHER THAN EDGE OF PAVEMENT AT XX, SAME AS TOP OF CURB

CG-12 DETECTABLE WARNING SURFACE

VIRGINIA DEPARTMENT OF TRANSPORTATION

TYPE C (PARALLEL & PERPENDICULAR) APPLICATION

A TRUNCATED DOMES
SEE SHEET 1 OF 5 FOR DETAILS

TANGENT PLAN

SECTION A-A

TYPE C PARALLEL & PERPENDICULAR

THE REQUIRED LENGTH OF A PARALLEL RAMP IS LIMITED TO 15 FEET, REGARDLESS OF THE SLOPE

4" CURB 6" CURB

20 :1 48: 1 MAX.



HERR

PREPARED: EL/JD/MK CHECKED: EM/MAB

DATE 04/28/14

REV 1 -


REV.2 -REV.3 -

SHEET NAME STANDARD DETAILS


DRAWING NUMBER


C8.

SHEET NUMBER 21 of 22

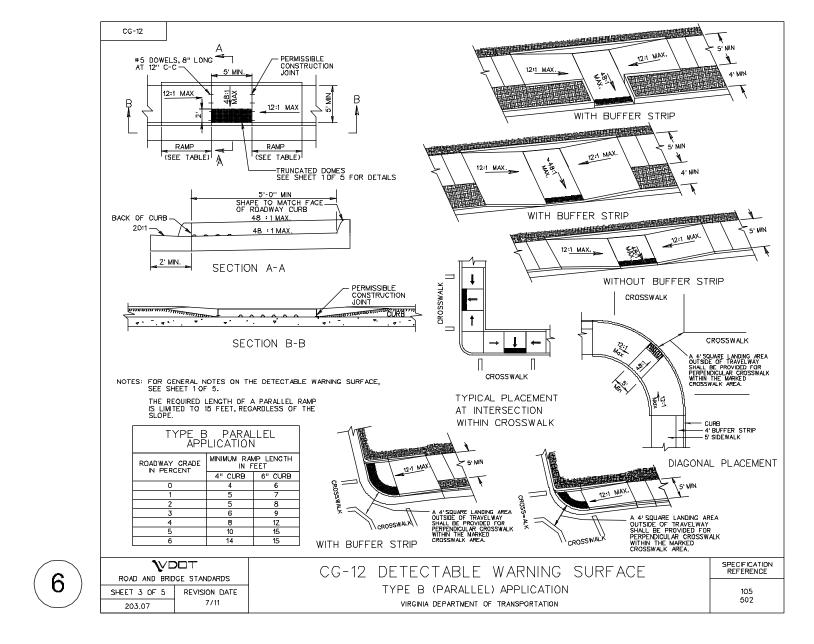

6

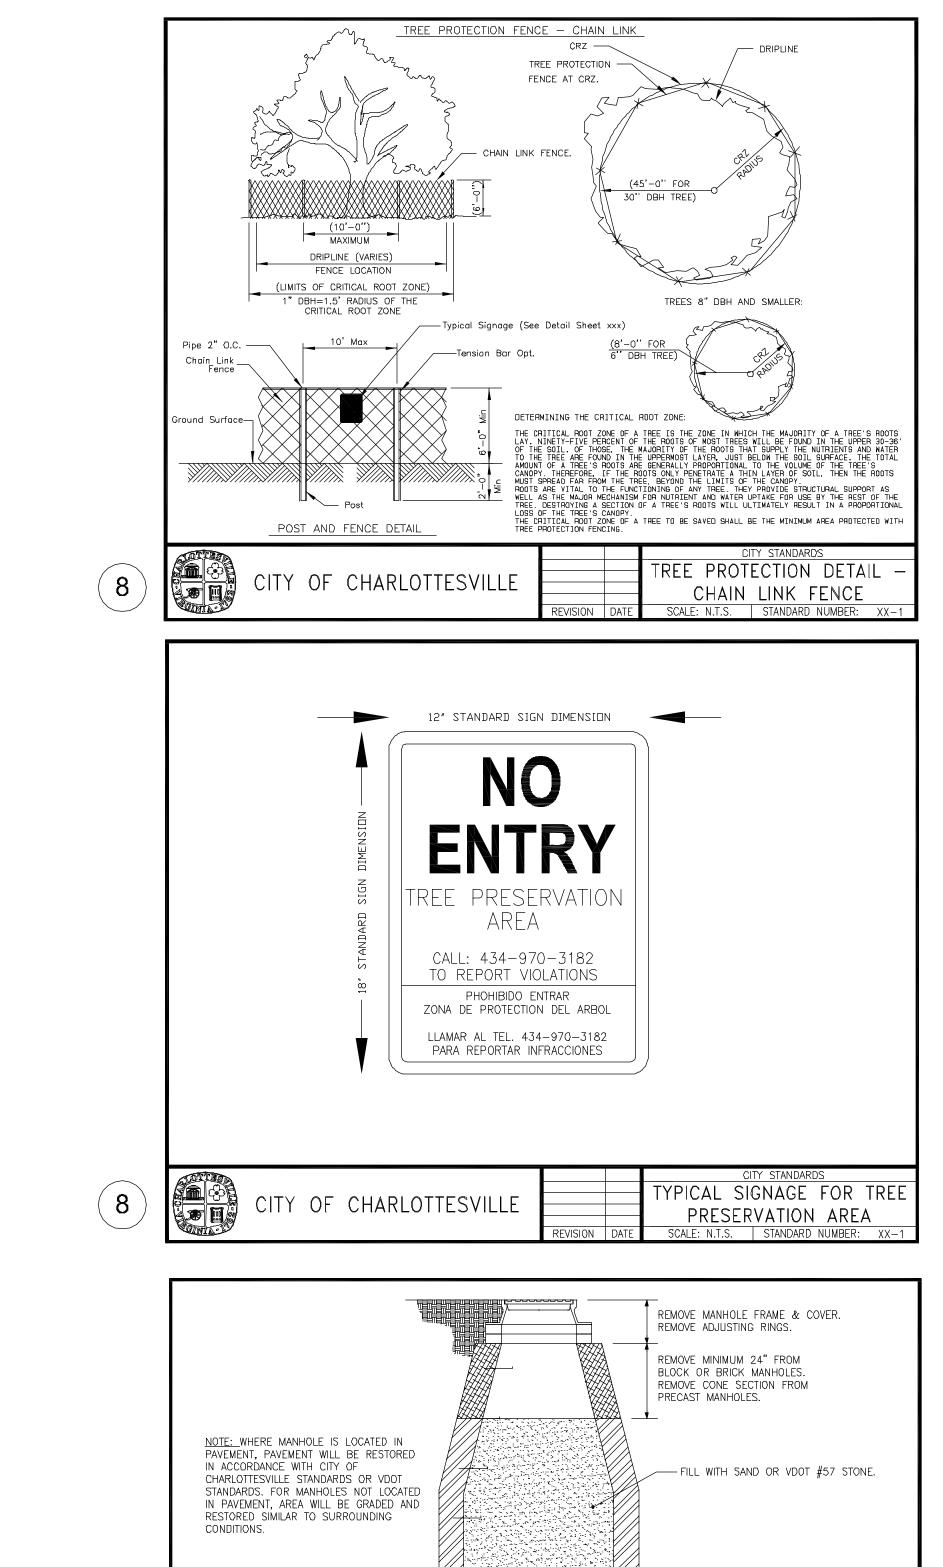

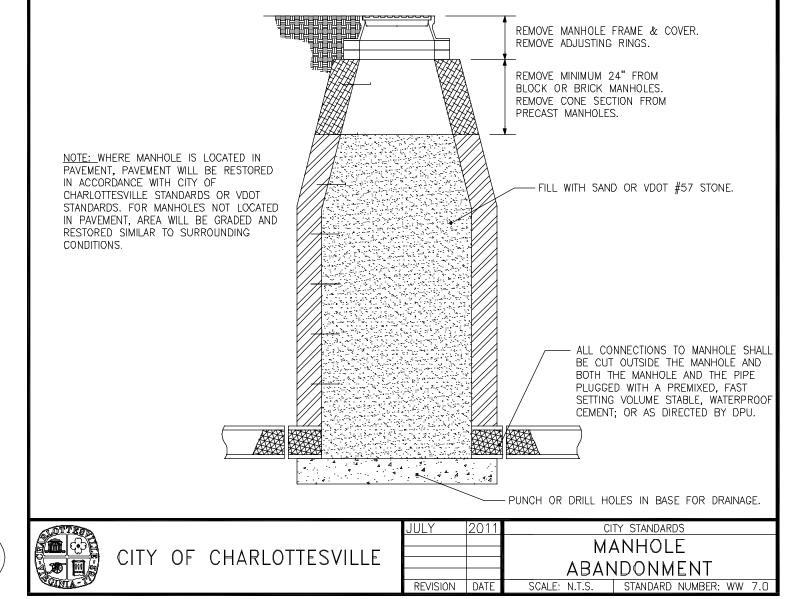



CHERRY AVENUE
7-1/2 STREET SW TO 6TH STREET SV
CHARLOTTESVILLE, VA

PREPARED: EL/JD/MK
CHECKED: EM/MAB

DATE 04/28/14

REV 1 -

SHEET NAME
STANDARD
DETAILS

DRAWING NUMBER

C8.2

SHEET NUMBER

22 OF 22